

MATANUSKA-SUSITNA BOROUGH

Planning and Land Use Department Development Services Division

350 East Dahlia Avenue • Palmer, AK 99645 Phone (907) 861-7822 • Fax (907) 861-8158 Email: permitcenter@matsugov.us

APPLICATION FOR A TALL STRUCTURE - MSB 17.67

Carefully read instructions and applicable borough code. Fill out forms completely. Attach information as needed. Incomplete applications will not be processed.

Application fee must be attached:	
\$1,500 for Conditional Use Permit -> 125 f	
X \$ 500 for Administrative Permit – 85' to 12	
\$ 100 for Network Improvement Permit -	In accordance with MSB 17.67.110.
Prior to the public hearing, the applicant must associated with the application. Applicants will be mailing charges. Payment must be made prior Borough Planning Commission or Planning Direct	e provided with a statement of advertising and to the application presentation before th
Subject Property Township:, Range: _	, Section:, Meridian
MSB Tax Account # 7762000L002	
SUBDIVISION: TKM ACKS	_BLOCK(S):, LOT(S): 2
STREET ADDRESS:	
(US Survey, Aliquot Part, Lat. /Long. etc)	S19N03E30
Ownership A written authorization by the owner must the owner is using one for the application. Is authorizated Name of Property Owner Charles Address: 10 1800 1800 1800 1800 1800 1800 1800	
Phne: Hm 9097 18 6202 Fax	Phne: Hm Fax
Wk 90 1349 9669 Cell 907 830 6202	Wk 303 448 8896 Cell 720-667-6652
E-mail dhousedra venelectric. com	E-mail hstrumpher@atlastowers.com
Special Land Use District (if applicable):	tton SPUD

	100.50
Permit#	10032

Pre-Application Requirements for New Tall Structures that Require a Conditional Use Permit

Prior to applying for a conditional use permit for a new tall structure, the applicant shall hold at least one community meeting.

- 1. The meeting shall be held at the nearest facility where community council meetings are regularly scheduled. If the facility is not available, the nearest available public facility that is capable of seating a minimum of 20 people shall be utilized.
- 2. The meeting shall be held at least 15 calendar days after mailing of the notification.
- 3. The meeting shall not start prior to 5:00 p.m. and no later than 7:00 p.m.
- 4. Notification of the meeting shall, at a minimum, include the following:
 - Legal description and map of the general parcel, or parcels, within the coverage area under consideration for the telecommunication facility.
 - Description of the proposed development including height, design, lighting, potential access to the site and proposed service.
 - Date, time, and location of the informational meeting.
 - Contact name, telephone number, and address of applicant.
 - Comment form created by the borough that has a comment submittal deadline and provides options for submitting comments.
- 5. At a minimum, the notification area for the meeting shall include the following:
 - Property owners within one-half mile of the parcels under consideration for the proposed tall structure.
 - The nearest community council and any community council whose boundary is within 1200 feet of the parcels under consideration for the tall structure.

A wri	tten report summarizing the results of the community meeting shall be	Attached
prepai	red that includes the following information:	
1.	Dates and locations of all meetings where citizens were invited to discuss	
the potential applicant's proposal.		
2.	Content, dates mailed, and numbers of mailings, including letters, meeting	
	notices, newsletters and other publications.	
3.	Sign-in sheet(s) used at the meeting, that includes places for names,	
	address, phone numbers and other contact information such as e-mail	
	addresses.	
4.	A list of residents, property owners, and interested parties who have	
	requested in writing that they keep informed of the proposed development	
	through notices, newsletters, or other written materials.	
5.	The number of people who attended meetings.	
6.	Copies of written comments received at the meeting.	
7.	A certificate of mailing identifying all who were notified of the meeting.	
8.	A written summary that addresses the following:	
	• The substance of the public's written concerns, issues, and	
	problems.	
	 How the applicant has addressed, or intends to address, concerns, 	
	issues and problems expressed during the process.	
	· Concerns issues, and problems the applicant has not addressed or	
	does not intend to address and why.	

	10032	
Permit#	1000	

General application requirements for <u>Administrative</u> and <u>Conditional Use</u> <u>Permits</u>		
1.	Design drawings for the proposed tall structure, drawn to scale, and certified by a registered engineer or architect.	
2.	Citizen participation report (if applying for a Conditional Use Permit)	
	Certified site plan (As defined in MSB 17.125.010)	
4.	Copy of a determination of no hazard to air navigation from the Federal Aviation Administration.	
5.	If breakpoint technology is intended to be utilized, a written statement specifying the height at which the engineered structural weakness will be located.	

	ler to grant a Conditional Use Permit or Administrative Permit the	Attached
Plann	ing Commission or Planning Director must find that each of the	
	ing criteria has been met. Explain the following in detail:	
1.	To the extent that is technically feasible and potentially available, the	
	location of the tall structure is such that its negative effects on the visual and scenic resources of all surrounding properties have been minimized.	
2.	Visibility of the tall structure from public parks, trails recognized within adopted MSB plans, and waterbodies has been minimized to the extent that is technically feasible and potentially available.	
3.	The tall structure will not interfere with the approaches to any existing airport or airfield that are identified in the MSB Regional Aviation System Plan or by the Alaska State Aviation System Plan.	
4.	That granting the permit will not be harmful to the public health, safety, convenience, and welfare.	

Application requirements for a Network Improvement Permit		Attached
1.	A description of the proposed modifications to the telecommunication tower, including a description of the height, type, and lighting of the new	
	or modified structure and the existing structure.	
2.	A certified site (as defined in MSB 17.125.010) for purposes of setback	
	verification.	
3.	Design drawings for the proposed modified or new structure, drawn to	
	scale, and certified by a registered engineer or architect.	

must	ler to grant a <u>Network Improvement Permit</u> the Planning Director find that each of the following criteria has been met. Explain the ing in detail.	Attached
	· ·	
ı.	The proposed development conforms to setback requirements of MSB	
	17.55.	
2.	The telecommunication tower being extended was lawfully constructed at	
	the time of application for a Network Improvement Permit.	
3.	The proposed modification does not violate permit conditions of any	
	valid permits that have been issued to the existing facility, provided that	
	the condition being violated does not limit height of the structure.	

Revised 7/21/21

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Opera Admi	tion Standards for New Tall Structures – Conditional Use Permit, nistrative Permit, and Network Improvement Permit	Attached
1.	The equipment compound shall meet minimum setback distances from all property lines in accordance with MSB 17.55	
2.	Setbacks shall be determined from the dimensions of the entire lot, even though the tower may be located on lease areas within the lot.	
3.	Adequate vehicle parking shall be provided on the subject property, outside of public use easements and rights-of-way to enable emergency vehicle access. No more than two spaces per provider shall be required.	
4.	Information signs for the purpose of identifying the tower such as the antenna structure registration number required by the Federal Communications Commission, as well as the party responsible for the operation and maintenance of the facility shall be visibly posted at the equipment compound.	
5.	If more than 220 volts are necessary for the operation of the facility, warning signs shall be located at the base of the facility and shall display in large, bold, high contrast letters the following: "HIGH VOLTAGE – DANGER".	
6.	A 24-hour emergency contact number shall be visibly posted at the equipment compound.	
7.	A fence or wall not less than six (6) feet in height with a secured gate shall be maintained around the base of the tower.	

Additional Standards for <u>Wind Energy Conversion Systems</u> (WECS) – In addition to the operations standards for new tall structures, the following standards shall apply to WECS	Attached
1. WECS shall be equipped with an automatic overspeed control device designed to protect the system form sustaining structural failure such as splintered or thrown blades and the overturning or breaking of towers due to an uncontrolled condition brought on by high winds.	
 WECS shall have a manually operable method that assures the WECS can be brought to a safe condition in high winds. Acceptable methods include mechanical or hydraulic brakes or tailvane deflection systems which turn the rotor out of the wind. 	

OWNER'S STATEMENT: I am owner of the following property:	
MSB Tax parcel ID #(s) <u>5315-26</u>	and,
I hereby apply for approval conditional use permit on that property as described in this application.	
I understand all activity must be conducted in compliance with all applicable standards of MSB and with all other applicable borough, state or federal laws.	
I understand that other rules such as local, state and federal regulations, covenants, plat notes, and restrictions may be applicable and other permits or authorization may be required. I understand the borough may also impose conditions and safeguards designed to protect the public's health, safety welfare and ensure the compatibility of the use with other adjacent uses.	at the

I understand that it is my responsibility to identify and comply with all applicable rules and conditions, covenants, plat notes, and deed restrictions, including changes that may occur in such requirements.

I understand that this permit and zoning status may transfer to subsequent owners of this land and that it is my responsibility to disclose the requirements of this status to the buyer when I sell the land.

I understand that changes from the approved conditional use permit may require further authorization by the Borough Planning Commission. I understand that failure to provide applicable documentation of compliance with approved requirements, or violation of such requirements will nullify legal status, and may result in penalties.

I grant permission for borough staff members to enter onto the property as needed to process this application and monitor compliance. Such access will at a minimum, be allowed when the activity is occurring and, with prior notice, at other times necessary to monitor compliance.

The information submitted in this application is	accurate and complete to the be	est of my knowledge.
Charles A Huse.	Charles D House	3/22/24
Signature: Property Owner	Printed Name	Date
Hamoret	Helmundt Strumpher	
Signature: Agent	Printed Name	Date
MSB USE ONLY		
Date application submitted:		
Date application determined complete:		

PERMIT CENTER – FEE RECEIPT FORM

Property Location: 776 2000LOOZ Applicant: Atlas Tower

USE PERMITS {100.000.000.341.300}	Fee
8.35 Public Display of Fireworks	\$25.00
8.40.010 Liquor License - Alcohol & Marijuana Control Office (AMCO) Referrals for Matanuska Susitna Borough Review of Issuance, renewal or transfer (location, owner)	\$100.00
8.41.010 Marijuana License - Alcohol & Marijuana Control Office (AMCO) Referrals for Matanuska Susitna Borough Review of Issuance, renewal or transfer (location, owner)	\$100.00
8.52 Temporary Noise Permit	\$1000.00
8.55 Special Events Permit 500 – 1000 Attendees 1000+ Attendees	\$500.00 \$1,000.00
8.55 Special Events Permit Site Monitor Fee / Per Day	\$300.00
17.02 Mandatory Land Use Permits	\$50.00
17.04 Nancy Lake Special Land Use District CUP	\$1,500.00
17.06 Electrical Generating & Delivery Facility Application	\$500.00
17.08 Hay Flats Special Land Use District Exception Application	\$1000.00
17.17 Denali State Park Conditional Use Permit	\$1500.00
17.18 Chickaloon Special Land Use District CUP	\$1500.00
17.19 Glacier View Special Land Use District CUP	\$1500.00
17.23 Port MacKenzie Development Permit	\$1000.00
17.25 Talkeetna Conditional Use Permit	\$1500.00
17.25 Talkeetna Conditional Use Permit – Variance	\$1500.00
17.27 Sutton Special Land Use District CUP	\$1500.00
17.29 Flood Damage Prevention Development Permit	\$100.00
17.29 Flood Damage Prevention Development Permit –Variance	\$500.00
17.30.040 Earth Materials Extraction Admin. Permit	\$1000.00
17.30.050 Earth Materials Extraction CUP	\$1500.00
17.36 Residential Planned Unit Development Application – Concept Plan – up to 50 Lots Additional Lots or tracts being created – Per Lot	\$500.00 \$100.00
17.48 Mobile Home Park Permit Application	\$500.00
17.52 Residential Land Use District App (Rezone)	\$1,000.0
17.52 Conditional Use Permit Application CUP	\$1,500.0
17.55 Shoreline Setback Exception Application	\$300.0
17.60 Conditional Use Permit Application	\$1500.0
17.61 Commercial/Industrial Core Area Conditional Use Permit	\$1500.0
17.62 Coal Bed Methane	\$1500.0

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	17.63 Conditional Use Permit for Racetracks	\$1500.00
	17.65 Variance	\$1500.00
2	17.67 Tall Structures - Network Improvement Permit	\$100.00
V	Nonconforming Use Administrative Permit	\$200.00 \$500.00
	Conditional Use Permit	\$1500.00
	17.70 Regulation of Alcoholic Beverage Use Permit Application	\$1500.00
	17.73 Multi-Family Land Use Permit – add \$25.00 for each additional unit beyond 5 units.	\$500.00
	17.75 Single-Family Residential Land Use District CUP	\$500.00
	17.76 Large Lot Single-Family Residential Land Use District Conditional Use Permit Application	\$1000.00
	17.80 Nonconforming Structures (Amnesty) Pre-Existing Legal Nonconforming (Grandfather)	\$300.00
	17.90 Regulation of Adult Businesses – Conditional Use Permit	\$300.00
	28.60 Timber Transport Permit	\$1500.00
		\$300.00
Medi	RIGHT-OF-WAY FEES:	
A S	Driveway	\$50.00
	Driveway Deposit {100.226.100}	\$150.00
	Construction	\$200.00
	Utility (Application Fee = \$100 ~ Distance Fee \$0.25/per lineal foot)	
	Encroachment	\$150.00
	Construction Bond {100.227.000}	
	PLATTING PRE-APPLICATION CONFERENCE:	ve orbital
	Pre-Application Fee	\$50.00
	FEES:	
	Flood Plain Development Survey CD	\$10.00
	CD/DVD/DVD-R	\$7.50
	Construction Manual/Title 43	\$5.00
	Plat Map/Tax Map Copies/Mylar	\$5.00
1	Color Maps	\$12.00
	Xerox Copies (B/W = \$0.25 ~ Color \$1.00/page 11X17 Color \$1.75/page)	
	Advertising Fees	
	Cultural Resources Books or Maps	
	Citation Payment (If sent to collections – use total due from Courtview)	
	Thumb Drive 2GB = \$5, 4GB = \$8, 8GB = \$10; 16GB = \$15; 32GB = \$20	

\$ 500 Amount Paid Date: 4/5/24 Receipt # 1629 By: MC

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Matanuska-Susitna Borough Finance 350 E Dahlia Avenue Palmer, AK 99645 907-861-8610

Welcome

04/08/2024 01:14PM Madeline C 000081-0002 000001629 Payment Effective Date 04/08/2024

MISCELLANEOUS RECEIPT

100000000 341300 -Planning - Platting -2024 Item: 57 1 @ \$500.0000 100000000 341300 -Planning - Platting -Map Fees

\$500.00

\$500.00

Subtotal \$500.00 Total \$500.00

CHECK \$500.00

Check Number 1223

Change due \$0.00

Paid by: ATLAS TOWER 1 LLC

Comments: ADMINISTRATIVE PERMIT TALL

STRUCTURES

Thank you for your payment

CUSTOMER COPY

Real Property Detail for Account: 57762000L002

Tax Map

Site Information

Account Number 57762000L002 Subdivision TKM AC Parcel ID 531526 City None

TRS S19N03E30 Map SU13 **Abbreviated Description** TKM AC LOT 2

(Not for Conveyance)

Ownership

HOUSE CHARLES D WOODWORTH-HOUSE Buyers Owners

Primary Owner's Address PO BOX 271 PALMER AK 99645-0271 **Primary Buyer's Address**

Appraisal Information Assessment

Year	L	and Appraised	Bldg. Appraised	Total Appraised	Year	Land Assessed	Bldg. Assessed	Total Assessed ¹
	2024	\$62,000.0	0 \$0.00	\$62,000.00	2024	\$62,000.00	\$0.00	\$62,000.00
	2023	\$62,000.0	0 \$0.00	\$62,000.00	2023	\$62,000.00	\$0.00	\$62,000.00
	2022	\$62,000.0	0 \$0.00	\$62,000.00	2022	\$62,000.00	\$0.00	\$62,000.00
Building Ir	nformation							
Building Ite	em Details							
Building N	Number	Description	1			Area	Percei	nt Complete
Tax/Billing	Information			Recorded Do	cuments			
Year Ce	rtified Z	one Mill	Tax Billed	Date	Туре		Recording Info (off	site link to DNR)
2024 Yes	s 00	020 16.59	3 \$1028.77					
2023 Yes	3 00	020 16.24	8 \$1007.37					
2022 Yes	s 00	020 16.75	8 \$1038.99					
Tax Accour	nt Status ²							
Status		Tax Balanc	e Farm		Disabled Veteran	Senior	Total ³	LID Exists

Current \$1,028.77 \$0.00 \$0.00 \$0.00 No Land and Miscellaneous

Gross Acreage Precinct Fire Service Area Road Service Area 49.59 Assembly District 001 29-530 004 Sutton FSA 031 Alpine RSA

Last Updated: 7/2/2024 2:00:01 PM

¹ Total Assessed is net of exemptions and deferments.rest, penalties, and other charges posted after Last Update Date are not reflected in balances.

² If account is in foreclosure, payment must be in certified funds.

³ If you reside within the city limits of Palmer or Houston, your exemption amount may be different.

Atlas Tower 1, LLC 3002 Bluff Street, Suite 300 Boulder, CO 80301 (303) 448-8896



March 22, 2024

Matanuska-Susitna Borough Development Services Division 350 E. Dahlia Ave Palmer, AK 99645

RE: Conditional Use Permit Narrative for Telecommunications Facility

Site Name: Sutton

To Whom It May Concern:

Atlas Tower 1, LLC is submitting a Conditional Use Permit Application to the Matanuska-Susitna Borough Development Services Division for review of a new proposed wireless telecommunications facility build on the property with Tax ID #7762000L002 / Parcel #: **\$19N03E30**. This letter shall serve as a narrative for the proposed 125' self support (Lattice) telecommunications facility and how this project will provide the needed mobile network coverage while reducing the need for additional cellular facilities in the future. This project is being proposed and this justification is being provided in an effort to alleviate current mobile network voice, data, and first responder issues in an area that is severely lacking reliable network coverage and capacity.

SITE DETAILS

Land Owner:

Charles D. House & Sonya S. Woodworth-House 18292 E Stayton Ave Palmer, AK, 99645

Applicant:

Atlas Tower 1, LLC 3002 Bluff St., Suite 300 Boulder, CO 80301

Zoning:

Sutton Special Land Use District

Site Address:

Mile 58 Road
Palmer, AK, 99645
Sutton Community Council
Parcel #: **\$19N03E30**

Coordinates:

Latitude: 61.702630 Longitude: -148.982128 Ground Elevation: 836'

Lease Area: 50 x 50

PROPOSAL SUMMARY

The purpose of this request is to build an 125' self support telecommunications tower within a 50×50 wireless facility. This facility will provide critical wireless coverage to the surrounding area. The proposed site is zoned TKM AC LOT2 where coverage is lacking, and the capacity of the existing infrastructure is reaching its limit. As the area develops further, and the existing users demand more data for their existing devices, existing infrastructure will reach capacity limits and be unable to meet coverage needs. This tower and facility will be used for structural support of up to four wireless providers. Each provider will install antennas and on-the-ground base-station equipment.

WIRELESS TELECOMMUNICATION FACILITY CHARACTERISTICS

Visual Effect

We strive to design our facilities and locate parcels that create the least amount of community disturbance. The surrounding area is a largely wooded rural area with low density residential zones nearby. The proposed site is chosen to maximize visual aesthetic and distance from residential homes. This site is setback from 1.23 miles from the Matanuska River in order to provide coverage to the area while minimizing visibility from the river. Applicant is likewise proposing an 125' facility in order to reduce any visual impact while still providing the necessary coverage to the nearby area.

<u>Frequency Of Maintenance Work On The Proposed Facility</u>

On average, after initial installation, a carrier or its contactors would likely visit the facility about one to four times a year for maintenance, though this number could vary depending on the specific circumstances of the facility.

The Average Number Of Vehicles Visiting The Facility

The average maintenance visit by a carrier or its contractors would likely involve one pickup truck. With an average of one to four visits a year and one truck a visit, there would likely be about one pickup truck visiting the site a month, per carrier, if at full capacity. Applicant shall be responsible for maintaining access to site, when needed, regardless of time of year. Applicant's proposed access meets all requirements concerning the MSB 11.12 – Driveway Standards.

The Average Duration Work Visits On The Facility

For typical maintenance visits, a carrier or its contactors would only be at the site a few hours, but this number could increase depending on the work that needed to be completed at the site.

Expected Noise Levels

Telecommunications facilities are essentially silent. This would be true whether there were one or four carriers. There will be emergency generators on site, however, would only be operated on site in the rare instance that power went out. The generators would create noise, but it would not be noticeable or audible outside of the location the telecommunications facility is proposed to be and only producing noise for a temporary amount of time during a local power outage.

Power and Utilities

This telecommunications will not require more than 220 volts for operation.

Setback Compliance

The proposed tower has been setback at least 125' from any property line in order to maintain compliance with the Matanuska Susitna Burrough Code requirements.

Site Security

The proposed tower shall be secured with a locked 8' chain link fencing with an addition 1' of barbed wire on top to prevent unauthorized visitors.

MSB Zoning Code Compliance; Public Health

The proposed tower does not and shall not waiver from any standards or requirements as written within the MATANUSKA-SUSITNA BOROUGH CODE. Likewise granting of this Conditional Use Permit will be

beneficial to the public health, safety, convenience, and welfare with the public having increased access to mobile network services and connectivity.

Building Codes; Safety Standards

Atlas Tower will ensure the structural integrity of towers, ensure that it is maintained in compliance with standards contained in applicable state or local building codes and the applicable standards for towers that are published by the Electronic Industries Association, as amended from time to time. Granting of this permit will not be harmful to the public health, safety, convenience, or welfare. If, upon inspection, Matanuska-Susitna Borough concludes that a tower fails to comply with such codes and standards and constitutes a danger to persons or property, then upon notice being provided to the owner of the tower, the owner shall have thirty (30) days to bring such tower into compliance with such standards, unless a longer time is reasonably necessary. Failure to bring such tower into compliance within said thirty (30) days shall constitute grounds for the removal of the tower or antenna at the owner's expense. Breakpoint technology will not be utilized in this tower.

FAA/FCC Compliance

Applicant has submitted the appropriate applications with the FAA & FCC but has yet to receive a determination. The proposed facility shall conform to the requirements of this title, this code, and other laws, including pertinent federal regulations of the Federal Communications Commission (FCC) and the Federal Aviation Administration's requirements regarding CFR Title 14 Part 77.9 (FAA) when determined, which is expected in August of 2024. If lighting is required, the lighting will be installed and maintained in accordance with the FAA and the certified site plans will be updated to reflect the lighting on the tower, if needed.

Access & Utility Easement Dedication

Applicant, upon Zoning approval of the site plan, will have all access and utility route surveyed and filed with the local recording district prior to construction of the tower.

This narrative represents required and supplementary information to document the technological, economic, and social necessity and benefits of a new 125' self-support (Lattice) telecommunications tower in Sutton. The information provided highlights the advantages associated with a telecommunications facility at our proposed site. See attached documents to showing our survey and tower drawings.

Atlas Tower 1, LLC respectfully requests the acceptance of our application for a Conditional Use Application for the proposed communications tower facility.

Best Regards,

Helmundt Strumpher 720-667-6652 www.atlastowers.com 3002 Bluff St. Suite 300 Boulder, CO 80301



Market: Sutton

House/Sutton 17 Mile Lake


Coverage analysis




Rad Center of 80/100/115/120 ft Comparison Initial Azimuths 0/160/260 LTE Design Analysis Pre/Post Upgrade




New Services Coverage (Existing Coverage without New Site)

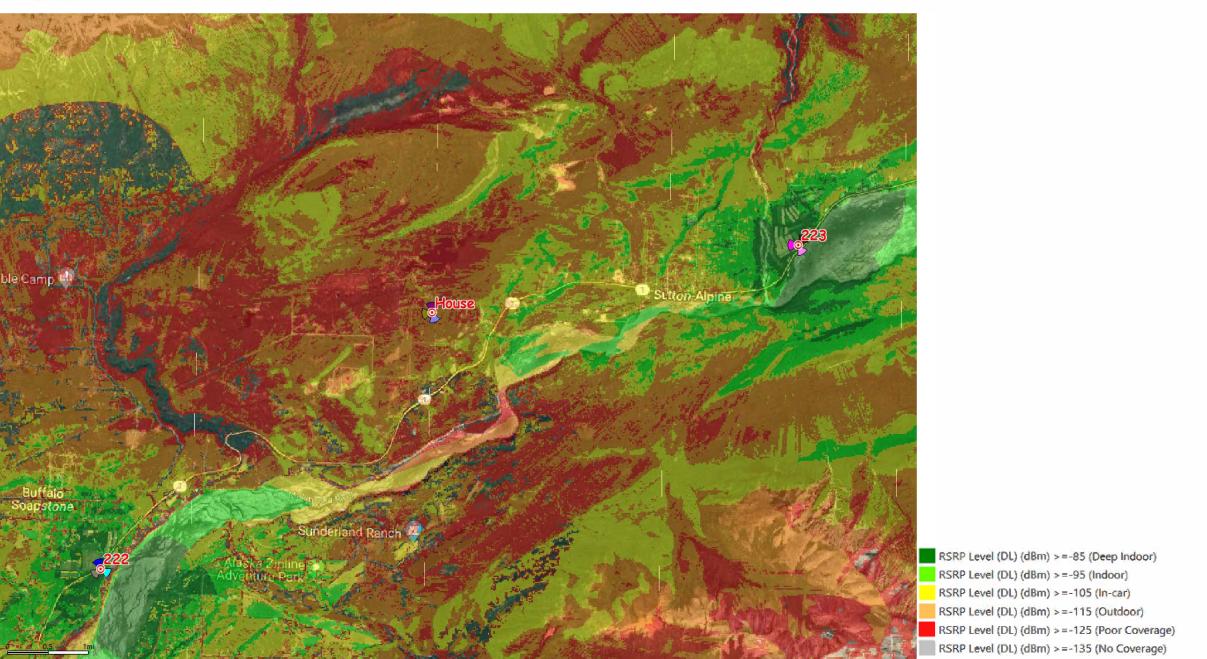




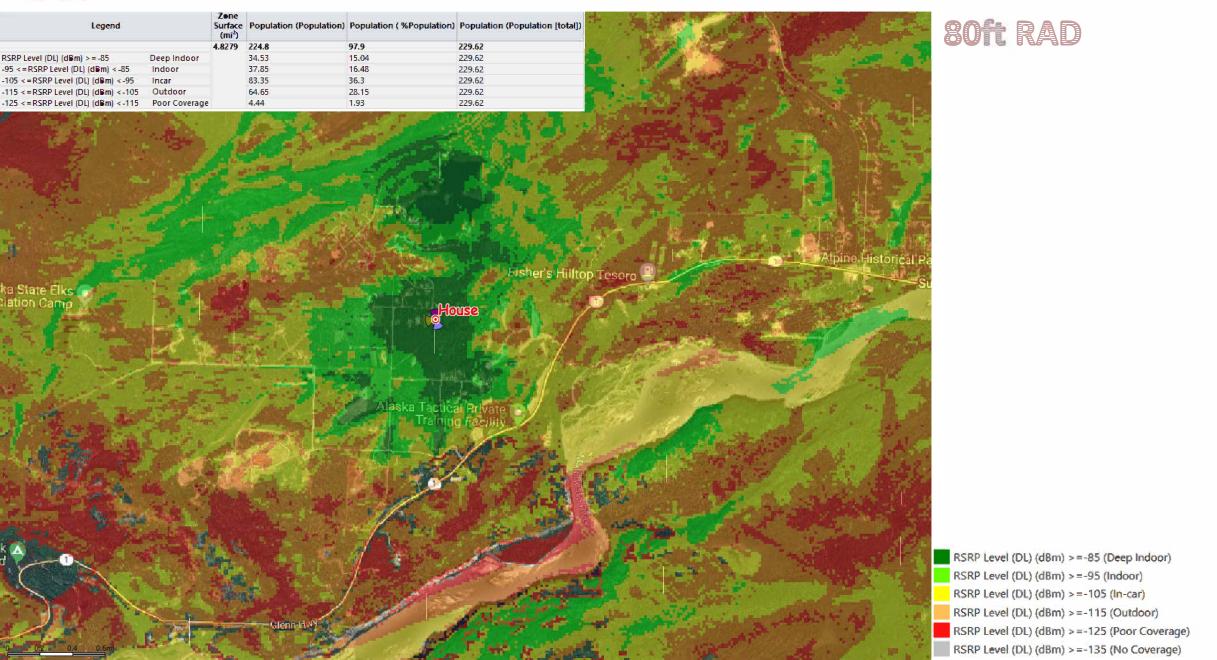




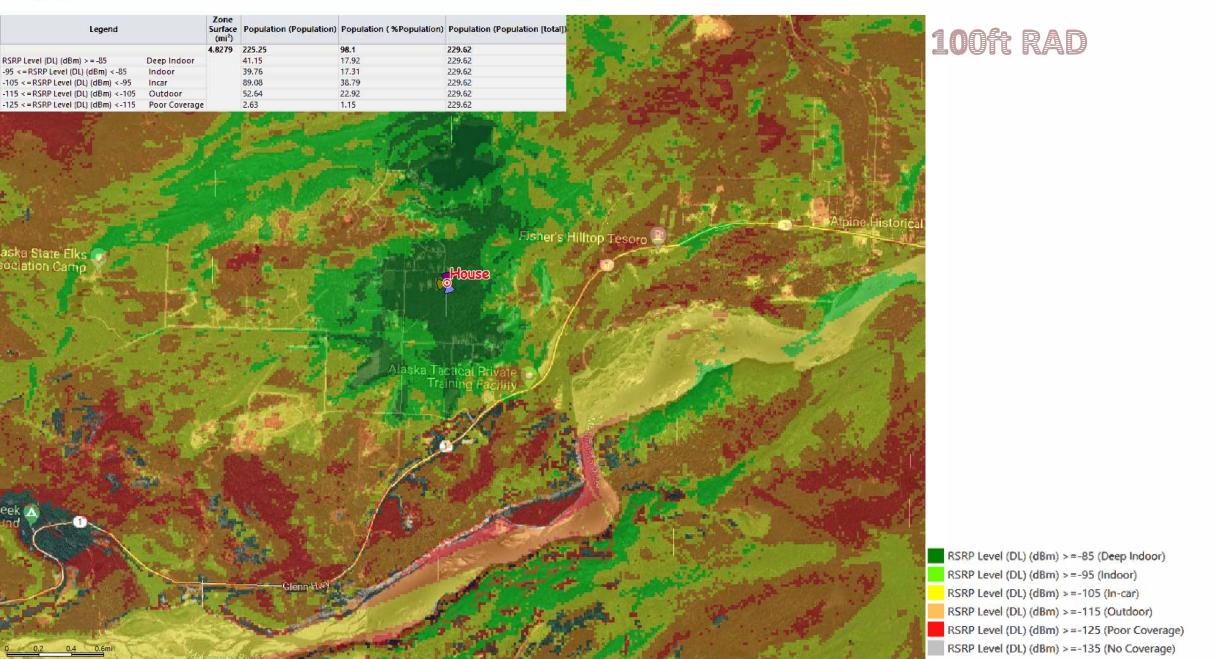



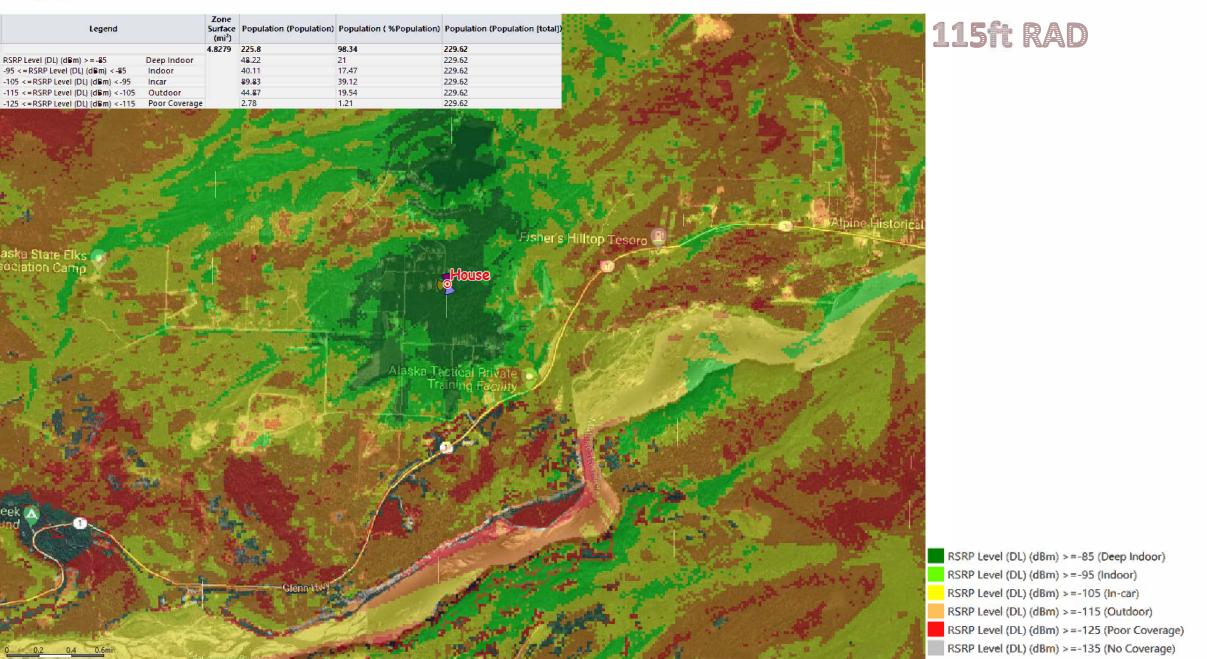



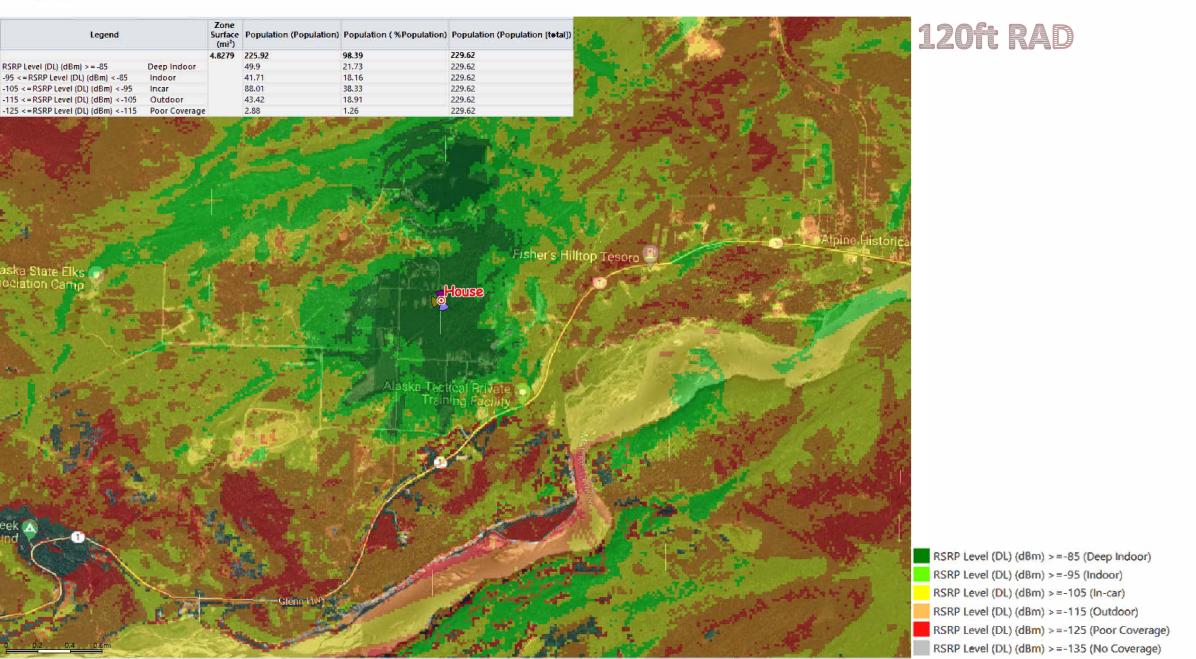



Conclusion

- We will meet coverage requirement better at the highest RAD @ 120ft
- 100ft is a good fallback RAD center if we cant Achieve 120ft

New Tower Location:

GPS Coordinates: 61.70263, -148.982128



State of Alaska

Department of Transportation and Public Facilities

Driveway Approval to Construct ATC 33536

Contact Name:

Helmundt Strumpher

Phone Number: (720) 466-1508

Owner:

Atlas Tower 1, LLC

Mailing Address:

2500 Bluff St. Suite 304

Boulder, CO 80030

Driveway Location: South one-half of the Southeast one-quarter (S1/2 SE1/4) Section 30, Township 19 North, Range 3 East, Seward Meridian, in the Records of the Palmer Recording District, Third Judicial District, Parcel ID # 531526

Approval to Construct Expires: 09/30/2026

This Approval to Construct (ATC) pertains only to State rights of way.

Driveway Provisions:

A copy of this ATC must be on site during construction of the driveway.

The State reserves the right to require the removal of all activities from the area if any conditions of this ATC are violated.

This ATC is not a property right but a temporary authorization revocable by the State upon violation of any provision, special conditions, or other reasons. All reasonable attorney's fees and costs associated with legal or enforcement actions related to the terms and conditions of this ATC will be borne by the Owner.

A driveway constructed within the State rights of way is the property of the State, but all cost and liability arising from the construction, operation, or maintenance of a driveway is at the sole expense of those lands served. The Department is not obligated to change its maintenance practices to accommodate a driveway or to incur any additional expense removing snow berms or other obstructions from a driveway within the rights of way resulting from the Department's activities, or activities under a permit issued under 17 AAC 15 (Utility and Railroad Permits).

Any survey monument or monument accessory which will be disturbed or destroyed during construction of the driveway, will be referenced prior to the disturbance and restored or replaced by a Land Surveyor licensed in the State of Alaska. The Land Surveyor must file a Monument Record in accordance with AS 34.65.040. All Monument Records will be reviewed by the Department prior to filing with the District Recorder.

The Owner is responsible for adjusting, relocating, or removing the access, without cost or liability to the Department, if the use or safety of the highway requires.

The Applicant/Owner, or their contractor, shall identify and coordinate with all Utilities that own, operate, or maintain facilities within the work area to relocate and/or adjust their facilities to accommodate the proposed improvements. The cost to relocate and/or adjust utility facilities shall be borne by the Applicant/Owner. Call 811 before performing any construction activities onsite.

The Owner will obtain all necessary Federal, State, and Municipal permits and licenses required by law. Note: for relocation or adjustment of any utility within State rights of way a Department of Transportation Utility Permit (or amendment as appropriate) is required.

The Owner will pay all taxes and special assessments lawfully imposed upon the permitted area and pay other fees and charges assessed under applicable law.

Placement of fill material in waters of the U.S., including wetlands and streams, requires prior authorization from the U.S. Army Corps of Engineers (USACE). It is the responsibility of the Owner to contact the USACE before filling activities take place.

The Owner will construct and maintain the driveway in such a manner that the highway, and all the highway's appurtenances or facilities, are not impaired or endangered in any way. These include drainage facilities, pipes, culverts, ditches, traffic control devices, streetlights, pathways, and sidewalks.

If, as a result of this project, any improvements within the State-owned rights of way are damaged, the Owner will be responsible for returning them to their previous condition.

No person will place, leave, or deposit upon any street, avenue, alley, sidewalk, or other public rights of way any snow or ice which has been removed from a private driveway, private parking area, or the adjacent property. The Owner is responsible for their snow removal contractor's actions concerning placement of snow from Owner's property.

The Owner will indemnify, defend, and hold harmless the State, and its officers, employees, and contractors, from any and all claims or actions resulting from injury, death, loss, or damage sustained by any person or personal property resulting directly or indirectly from Owner's use of or activities in the area.

No equipment or materials are permitted on the shoulder during non-working hours.

All litter and debris generated due to this project must be removed and properly disposed of by the contractor. The Owner will be responsible for all costs incurred by the State associated with clean up or restoration of the State rights of way.

If a culvert is required by this ATC, the following applies:

- Culvert length and ditch depth, as stipulated in the Design Criteria, are generally based on information supplied by the applicant, and must be verified on site during construction,
- Culvert and culvert ends must be installed at time of the driveway construction,
- Ensure a minimum ground cover of 12-inches is over the culvert prior to paving,
- Maintain existing drainage patterns.

The Owner will pave from the edge of pavement to the radius return or the distance stipulated by the Design Criteria "Landing length." Prior to paving, saw-cut 12-inches from the edge of pavement and tack coat.

A permit for this driveway will be issued only after construction is complete and accepted by the Department of Transportation and Public Facilities.

Design Criteria:

A.	Driveway width	14	Feet	
B.	Left edge clearance	70	Feet	
C.	Right edge clearance	300	Feet	
D.	Left return radius	20	Feet	
E.	Right return radius	20	Feet	
F.	Shoulder width	2	Feet	
G.	Approach angle	90	Degrees	
H.	Curb type		n/a	
I.	Curb to sidewalk distance		n/a	
J.	Left driveway foreslope	6:1	Or match existing	
K.	Right driveway foreslope	6:1	Or match existing	
L.	Culvert length	22	Feet (field fit)	
M.	Landing grade	2	Percent	
N.	Landing length	20	Feet	
O.	Culvert size	18	Inches	
P.	Culvert type	Corrugat	ed Metal Pipe (CMP)	
Q.	Ditch depth	2	Peet Feet	
R.	Shoulder type		Gravel	
S.	Road surface type		Asphalt	
T.	Driveway surface type	Asphalt		

Traffic Control for Driveway Construction:

The Owner or their contractor shall obtain a Lane Closure Permit for any work that closes traffic lanes, roadway shoulder, or pathway/sidewalk.

Short term or short duration work within the right of way does not typically require a Lane Closure Permit provided it conforms to the table below:

	WORK ON THE SHOULDER	WORK BEYOND SHOULDER (ROADSIDE)		
DURATION	Less than 1 hour	Less than one day		
TIME OF DAY	Daylight conditions only			
BASIC TRAFFIC SAFETY REQUIREMENTS	Use high intensity rotating, flashing, oscillating or strobe light on top of a vehicles, visible for 700 feet or more in all directions. Wear orange work vests labeled as meeting ANSI/ISEA 107-2004 Class with Level 2 retroreflective material.			
WORK EXAMPLES	Offloading equipment to the roadside. Matching paved driveway to edge of roadway pavement. Sweeping the roadway shoulder.			

Do not park equipment within 30 feet of the edge of traveled way or within 10 feet of a curb when not working.

Special Conditions:

None Noted

Incorporated as part of this ATC:

• Site Plan

I, Helmundt Strumpher	the Tenant, acknowledge and accept that I will comply
with all the provisions and condition	is of this ATC.
DocuSigned by:	
Helmundt Strumpher	7/11/2024
Owner Signature	Date
Malle	7/15/24
DOT&PF Signature W	Date

SITE NAME: SUTTON

PROJECT DESCRIPTION: PROPOSED

TELECOMMUNICATIONS

FACILITY

125' SELF SUPPORT TOWER **TOWER TYPE:**

SITE ADDRESS: **UNASSIGNED ADDRESS**

MILE 58 RD

SUTTON, AK 99645

AREA OF 9,155± SQ. FT. CONSTRUCTION: (L.O.D.A)

JURISDICTION: **MATANUSKA SUSITNA**

> **BOROUGH** UNKNOWN

PARCEL #: 7762000L002

ZONING:

PROJECT INFORMATION

N 61° 42' 09.793129" (NAD '83) LATITUDE LONGITUDE W 148° 58' 54.024660" (NAD '83)

GROUND ELEVATION 843.29' (NAVD '88)

* INFORMATION PROVIDED IN A SURVEY PERFORMED BY FARPOINT LAND SERVICES, LLC DATED APRIL 14, 2024.

SITE COORDINATES




LOCATION MAP

TAKE AVIATION AVE TO S CLAPP ST/S MACK DR, HEAD NORTHWEST ON CROSSWIND CT TOWARD AVIATION AVE, TURN RIGHT ONTO AVIATION AVE TAKE AK-3 S. E BOGARD RD, FISHHOOK-WILLOW RD/N PALMER-FISHHOOK RD AND AK-1 N TO MILE 58 RD IN SUTTON-ALPINE, TURN LEFT ONTO S CLAPP ST/S MACK DR,TURN RIGHT ONTO AK-3 S TURN LEFT ONTO N CRUSEY ST, CONTINUE STRAIGHT TO STAY ON N CRUSEY ST.TURN RIGHT ONTO E BOGARD RD AT THE ROUNDABOUT, TAKE THE 1ST EXIT AND STAY ON E BOGARD RD AT THE ROUNDABOUT, TAKE THE 3RD EXIT CONTINUE ONTO N TRUNK RD TURN RIGHT ONTO FISHHOOK-WILLOW RD/N PALMER-FISHHOOK RD.TURN LEFT ONTO AK-1 N DRIVE TO MILE 58 RD TURN LEFT ONTO MILE 58 RD (SIGNS FOR PALMER CORRECTIONAL CTR) TURN RIGHT TO STAY ON MILE 58 RD DESTINATION WILL BE ÓN THE RIGHT.

DRIVING DIRECTIONS

ER JIEP

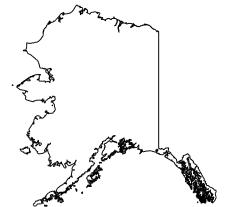

SITE NAME: SUTTON

MILE 58 RD **SUTTON, AK 99645** (MATANUSKA SUSITNA BOROUGH)

CALL FOR UNDERGROUND UTILITIES PRIOR TO DIGGING

(800) 662-4111 EMERGENCY:

CALL 911

NAME:

NAME:

ADDRESS:

CONTACT:

CONTACT:



ALL WORK AND MATERIALS SHALL BE PERFORMED AND INSTALLED IN ACCORDANCE WITH THE CURRENT EDITIONS OF THE FOLLOWING CODES AS ADOPTED BY THE LOCAL GOVERNING AUTHORITIES. NOTHING IN THESE PLANS IS TO BE CONSTRUED TO PERMIT WORK NOT CONFORMING TO THE LATEST EDITIONS OF THE FOLLOWING:

T.B.D.

- (2015 EDITION)
- INTERNATIONAL CODE COUNCIL 5. CBC/TIA-222-G 6.
- INTERNATIONAL BUILDING CODE 4. NATIONAL ELECTRIC CODE
 - (2014 EDITION)
 LOCAL BUILDING CODE
 CITY/COUNTY ORDINANCES
- REGULATIONS.
 THIS IS AN UNMANNED FACILITY WHICH WILL NOT REQUIRE ANY WATER OF SEWER FACILITIES.
 - TRAFFIC WILL CONSIST ONLY OF MAINTENANCE PERSONNEL, VISITING THE SITI APPROXIMATELY TWICE A MONTH.

PROJECT DESCRIPTION & NOTES

CONSTRUCTION OF A TELECOMMUNICATION FACILITY, CONSISTING OF ANTENNAS & ASSOCIATED APPURTENANCES ON A PROPOSED SELF SUPPORT TOWER, FENCED COMPOUND & SERVICE EQUIPMENT FOR FUTURE CARRIERS. NO WATER OR SEWER IS REQUIRED.

FACILITY DESIGNED IN ACCORDANCE WITH MATANUSKA-SUSITNA BOROUGH

CODE COMPLIANCE

ITH ITHE

METER # NEAR SITE:

UTILITIES:	
POWER COMPANY: ADDRESS:	T.B.D. UNKNOWN UNKNOWN

SANDRA LAYTON (801) 732-0624

SITE APPLICANT:

ORIGINAL SURVEYOR: NAME: FARPOINT LAND SERVICES, LLC 1131 E 76TH AVE, SUITE 101 CITY, STATE, ZIP: ANCHORAGE, AK 99518 PHONE: (907) 522-7770

WIBLUE, INC. COREY BONNER

(986) 206-7071

WiBLUE, INC

2500 30TH STREET, SUITE 304

CITY, STATE, ZIP: BOULDER, CO 80301

SITE CONSTRUCTION MANAGER:

CIVIL ENGINEER:

NAME: TEP OPCO, LLC 326 TRYON ROAD CONTACT:

SZO INTO INCOME

RALEIGH, NC 27603

ANDREW HALDANE, P.E. (919) 661-6351

ELECTRICAL ENGINEER:

NAME: TEP OPCO. LLC ADDRESS: 326 TRYON ROAD CITY, STATE, ZIP: RALEIGH, NC 27603 ANDREW HALDANE, P.E. (919) 661-6351 CONTACT: PHONE:

PROPERTY OWNER:

NAME: CHARLES HOUSE & SONYA WOODWORTH-HOUSE PO BOX 271

CITY, STATE, ZIP: PALMER, AK 99645-0271

FACILITY OWNER:

NAME: ATLAS TOWER 1, LLC ADDRESS: 2500 30TH STREET, SUITE 304 CITY, STATE, ZIP: BOULDER, CO 80301


CONTACT INFORMATION

SHEET DESCRIPTION **REV** TITLE SHEET GENERAL NOTES 0 AREA PLAN C1 0 SITE PLAN 0 C3 COMPOUND DETAIL 0 C4 TOWER ELEVATION 0 FENCE DETAILS 0 SOIL & EROSION CONTROL PLAN C6 1 SILT FENCE DETAILS 0 C7 DRIVEWAY DETAILS 0 C8 SIGNAGE DETAILS 0 E1 **ELECTRICAL NOTES** 0 POWER PLAN & ONE-LINE DIAGRAM E2 0 SERVICE RACK DETAILS 0 GROUNDING PLAN & DETAILS 0 F4 E5 GROUNDING DETAILS 0 TOWER FOUNDATION GROUNDING DETAILS **INDEX OF SHEETS**


PLANS PREPARED BY:



4700 DAHLIA STREET **DENVER, CO 80216** OFFICE: (303) 566-9914 www.tepgroup.net

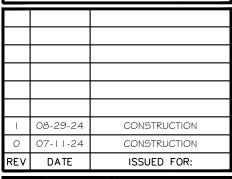

DRAWN BY: CHECKED BY:

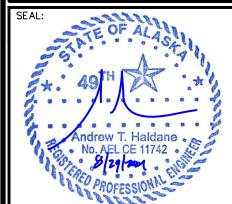

SEAL:

SHEET NUMBER:

REVISION:

TEP#:338102.423

GENERAL NOTES:

- 1. ALL REFERENCES TO OWNER IN THESE DOCUMENTS SHALL BE CONSIDERED ATLAS 1, LLC, OR ITS DESIGNATED REPRESENTATIVE.
- 2. ALL WORK PRESENTED ON THESE DRAWINGS MUST BE COMPLETED BY THE CONTRACTOR UNLESS NOTED OTHERWISE. THE CONTRACTOR MUST HAVE CONSIDERABLE EXPERIENCE IN PERFORMANCE OF WORK SIMILAR TO THAT DESCRIBED HEREIN. BY ACCEPTANCE OF THIS ASSIGNMENT, THE CONTRACTOR IS ATTESTING THAT HE DOES HAVE SUFFICIENT EXPERIENCE AND ABILITY, THAT HE IS KNOWLEDGABLE OF THE WORK TO BE PERFORMED AND THAT HE IS PROPERLY LICENSED AND PROPERLY REGISTERED TO DO THIS WORK IN THE STATE OF ALASKA.
- 3. STRUCTURE IS DESIGNED IN ACCORDANCE WITH ANSI/TIA/EIA-222-H. THIS CONFORMS TO THE REQUIREMENTS OF THE INTERNATIONAL BUILDING CODE, 2015 EDITION.
- 4. WORK SHALL BE COMPLETED IN ACCORDANCE WITH THE INTERNATIONAL BUILDING CODE. 2015 EDITION.
- 5. UNLESS SHOWN OR NOTED OTHERWISE ON THE CONTRACT DRAWINGS, OR IN THE SPECIFICATIONS, THE FOLLOWING NOTES SHALL APPLY TO THE MATERIALS LISTED HEREIN, AND TO THE PROCEDURES TO BE USED ON THIS PROJECT.
- 6. ALL HARDWARE ASSEMBLY MANUFACTURER'S INSTRUCTIONS SHALL BE FOLLOWED EXACTLY AND SHALL SUPERCEDE ANY CONFLICTING NOTES ENCLOSED HEREIN.
- 7. IT IS THE CONTRACTOR'S SOLE RESPONSIBILITY TO DETERMINE ERECTION PROCEDURE AND SEQUENCE TO ENSURE THE SAFETY OF THE STRUCTURE AND IT'S COMPONENT PARTS DURING ERECTION AND/OR FIELD MODIFICATIONS. THIS INCLUDES, BUT IS NOT LIMITED TO, THE ADDITION OF TEMPORARY BRACING, GUYS OR TIE DOWNS THAT MAY BE NECESSARY. SUCH MATERIAL SHALL BE REMOVED AND SHALL REMAIN THE PROPERTY OF THE CONTRACTOR AFTER THE COMPLETION OF THE PROJECT.
- 8. ALL DIMENSIONS, ELEVATIONS, AND EXISTING CONDITIONS SHOWN ON THE DRAWINGS SHALL BE FIELD VERIFIED BY THE CONTRACTOR PRIOR TO BEGINNING ANY MATERIALS ORDERING, FABRICATION OR CONSTRUCTION WORK ON THIS PROJECT. CONTRACTOR SHALL NOT SCALE CONTRACT DRAWINGS IN LIEU OF FIELD VERIFICATIONS. ANY DISCREPANCIES SHALL BE IMMEDIATELY BROUGHT TO THE ATTENTION OF THE OWNER AND THE OWNER'S ENGINEER. THE DISCREPANCIES MUST BE RESOLVED BEFORE THE CONTRACTOR IS TO PROCEED WITH THE WORK. THE CONTRACT DOCUMENTS DO NOT INDICATE THE METHOD OF CONSTRUCTION. THE CONTRACTOR SHALL SUPERVISE AND DIRECT THE WORK AND SHALL BE SOLELY RESPONSIBLE FOR ALL CONSTRUCTION MEANS, METHODS, TECHNIQUES, SEQUENCES, AND PROCEDURES. OBSERVATION VISITS TO THE SITE BY THE OWNER AND/OR THE ENGINEER SHALL NOT INCLUDE INSPECTION OF THE PROTECTIVE MEASURES OR THE PROCEDURES.
- 9. ALL MATERIALS AND EQUIPMENT FURNISHED SHALL BE NEW AND OF GOOD QUALITY, FREE FROM FAULTS AND DEFECTS AND IN CONFORMANCE WITH THE CONTRACT DOCUMENTS. ANY AND ALL SUBSTITUTIONS MUST BE PROPERLY APPROVED AND AUTHORIZED IN WRITING BY THE OWNER AND ENGINEER PRIOR TO INSTALLATION. THE CONTRACTOR SHALL FURNISH SATISFACTORY EVIDENCE AS TO THE KIND AND QUALITY OF THE MATERIALS AND EQUIPMENT BEING SUBSTITUTED.
- 10. THE CONTRACTOR SHALL BE RESPONSIBLE FOR INITIATING, MAINTAINING, AND SUPERVISING ALL SAFETY PRECAUTIONS AND PROGRAMS IN CONNECTION WITH THE WORK. THE CONTRACTOR IS RESPONSIBLE FOR ENSURING THAT THIS PROJECT AND RELATED WORK COMPLIES WITH ALL APPLICABLE LOCAL, STATE, AND FEDERAL SAFETY CODES AND REGULATIONS GOVERNING THIS WORK
- 11. ACCESS TO THE PROPOSED WORK SITE MAY BE RESTRICTED. THE CONTRACTOR SHALL COORDINATE INTENDED CONSTRUCTION ACTIVITY, INCLUDING WORK SCHEDULE AND MATERIALS ACCESS, WITH THE RESIDENT LEASING AGENT FOR APPROVAL.
- 12. BILL OF MATERIALS AND PART NUMBERS LISTED ON CONSTRUCTION DRAWINGS ARE INTENDED TO AID CONTRACTOR. CONTRACTOR SHALL VERIFY PARTS AND QUANTITIES WITH MANUFACTURER PRIOR TO BIDDING AND/OR ORDERING MATERIALS.
- 13. ALL PERMITS THAT MUST BE OBTAINED ARE THE RESPONSIBILITY OF THE CONTRACTOR. THE CONTRACTOR WILL BE RESPONSIBLE FOR ABIDING BY ALL CONDITIONS AND REQUIREMENTS OF THE PERMITS.
- 14. 24 HOURS PRIOR TO THE BEGINNING OF ANY CONSTRUCTION, THE CONTRACTOR MUST NOTIFY THE APPLICABLE JURISDICTIONAL (STATE, COUNTY OR CITY) ENGINEER.
- 15. THE CONTRACTOR SHALL REWORK (DRY, SCARIFY, ETC.) ALL MATERIAL NOT SUITABLE FOR SUBGRADE IN ITS PRESENT STATE. AFTER REWORKING, IF THE MATERIAL REMAINS UNSUITABLE, THE CONTRACTOR SHALL UNDERCUT THIS MATERIAL AND REPLACE WITH APPROVED MATERIAL. ALL SUBGRADES SHALL BE PROOFROLLED WITH A FULLY LOADED TANDEM AXLE DUMP TRUCK PRIOR TO PAVING. ANY SOFTER MATERIAL SHALL BE REWORKED OR REPLACED.
- 16. THE CONTRACTOR IS REQUIRED TO MAINTAIN ALL PIPES, DITCHES, AND OTHER DRAINAGE STRUCTURES FREE FROM OBSTRUCTION UNTIL WORK IS ACCEPTED BY THE OWNER. THE CONTRACTOR IS RESPONSIBLE FOR ANY DAMAGES CAUSED BY FAILURE TO MAINTAIN DRAINAGE STRUCTURE IN OPERABLE CONDITION.
- 17. ALL MATERIALS AND WORKMANSHIP SHALL BE WARRANTED FOR ONE YEAR FROM ACCEPTANCE DATE.
- 18. ALL BUILDING DIMENSIONS SHALL BE VERIFIED WITH THE PLANS (LATEST REVISION) PRIOR TO COMMENCING CONSTRUCTION. NOTIFY THE ENGINEER IMMEDIATELY IF ANY DISCREPANCIES ARE DISCOVERED. THE OWNER SHALL HAVE A SET OF APPROVED PLANS AVAILABLE AT THE SITE AT ALL TIMES WHILE WORK IS BEING PERFORMED. A DESIGNATED RESPONSIBLE EMPLOYEE SHALL BE AVAILABLE FOR CONTACT BY GOVERNING AGENCY INSPECTORS.

STRUCTURAL STEEL NOTES:

- 1. THE FABRICATION AND ERECTION OF STRUCTURAL STEEL SHALL CONFORM TO THE AISC SPECIFICATION FOR MANUAL OF STEEL CONSTRUCTION, 14TH EDITION.
- 2. UNLESS OTHERWISE NOTED, ALL STRUCTURAL ELEMENTS SHALL CONFORM TO THE FOLLOWING REQUIREMENTS:

 A. STRUCTURAL STEEL, ASTM DESIGNATION A36 OR A992 GR50.
 - B. ALL BOLTS, ASTM A325 TYPE I GALVANIZED HIGH STRENGTH BOLTS.
 - C. ALL NUTS, ASTM A563 CARBON AND ALLOY STEEL NUTS.
 - D. ALL WASHERS, ASTM F436 HARDENED STEEL WASHERS.
- 3. ALL CONNECTIONS NOT FULLY DETAILED ON THESE PLANS SHALL BE DETAILED BY THE STEEL FABRICATOR IN ACCORDANCE WITH AISC SPECIFICATION FOR MANUAL OF STEEL CONSTRUCTION, 14TH EDITION.
- 4. HOLES SHALL NOT BE FLAME CUT THRU STEEL UNLESS APPROVED BY THE ENGINEER.
- 5. HOT-DIP GALVANIZE ALL ITEMS UNLESS OTHERWISE NOTED, AFTER FABRICATION WHERE PRACTICABLE. GALVANIZING: ASTM A123, ASTM A153/A153M OR ASTM A653/A653M, G90, AS APPLICABLE.
- 6. REPAIR DAMAGED SURFACES WITH GALVANIZING REPAIR METHOD AND PAINT CONFORMING TO ASTM A780 OR BY APPLICATION OF STICK OR THICK PASTE MATERIAL SPECIFICALLY DESIGNED FOR REPAIR OF GALVANIZING. CLEAN AREAS TO BE REPAIRED AND REMOVE SLAG FROM WELDS. HEAT SURFACES TO WHICH STICK OR PASTE MATERIAL IS APPLIED, WITH A TORCH TO A TEMPERATURE SUFFICIENT TO MELT THE METALLICS IN STICK OR PASTED; SPREAD MOLTEN MATERIAL UNIFORMLY OVER SURFACES TO BE COATED AND WIPE OFF EXCESS MATERIAL.
- 7. A NUT LOCKING DEVICE SHALL BE INSTALLED ON ALL PROPOSED AND/OR REPLACED BOLTS.
- 8. ALL PROPOSED AND/OR REPLACED BOLTS SHALL BE OF SUFFICIENT LENGTH TO EXCLUDE THE THREADS FROM THE SHEAR PLANE.
- 9. ALL PROPOSED AND/OR REPLACED BOLTS SHALL BE OF SUFFICIENT LENGTH SUCH THAT THE END OF THE BOLT BE AT LEAST FLUSH WITH THE FACE OF THE NUT. IT IS NOT PERMITTED FOR THE BOLT END TO BE BELOW THE FACE OF THE NUT AFTER TIGHTENING IS COMPLETED.
- 10. ALL ASSEMBLY BOLTS ARE TO BE TIGHTENED TO A "SNUG TIGHT" CONDITION AS DEFINED IN SECTION 8.1 OF THE AISC, "SPECIFICATION FOR STRUCTURAL JOINTS USING ASTM A325 OR A490 BOLTS", DATED JUNE 30, 2004.
- 11. FLAT WASHERS ARE TO BE INSTALLED WITH BOLTS OVER SLOTTED HOLES.
- 12. DO NOT OVER TORQUE ASSEMBLY BOLTS. GALVANIZING ON BOLTS, NUTS, AND STEEL PARTS MAY ACT AS A LUBRICANT, THUS OVER TIGHTENING MAY OCCUR AND MAY CAUSE BOLTS TO CRACK AND SNAP OFF.
- 13. PAL NUTS ARE TO BE INSTALLED AFTER NUTS ARE TIGHT AND WITH EDGE LIP OUT. PAL NUTS ARE NOT REQUIRED WHEN SELF-LOCKING NUTS ARE PROVIDED.
- 14. GALVANIZED ASTM A325 BOLTS SHALL NOT BE REUSED.
- 15. WELDING SHALL BE PERFORMED IN ACCORDANCE WITH AMERICAN WELDING SOCIETY (AWS) D1.1-2010 STRUCTURAL WELDING CODE STEEL.

PROJECT INFORMATION:

SUTTON

MILE 58 RD SUTTON, AK 99645 (MATANUSKA SUSITNA BOROUGH)

PLANS PREPARED FOR:




2500 30TH ST, SUITE 304 BOULDER, CO 80301 Office: (303) 448-8896

PLANS PREPARED BY:



TOWER ENGINEERING PROFESSIONALS 4700 DAHLIA STREET DENVER, CO 80216 OFFICE: (303) 566-9914 www.tepgroup.net

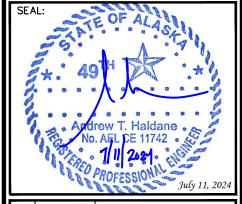

O 07-11-24 CONSTRUCTION
REV DATE ISSUED FOR:

DRAWN BY: KES CHECKED BY: ARE

SHEET TITLE:


GENERAL NOTES


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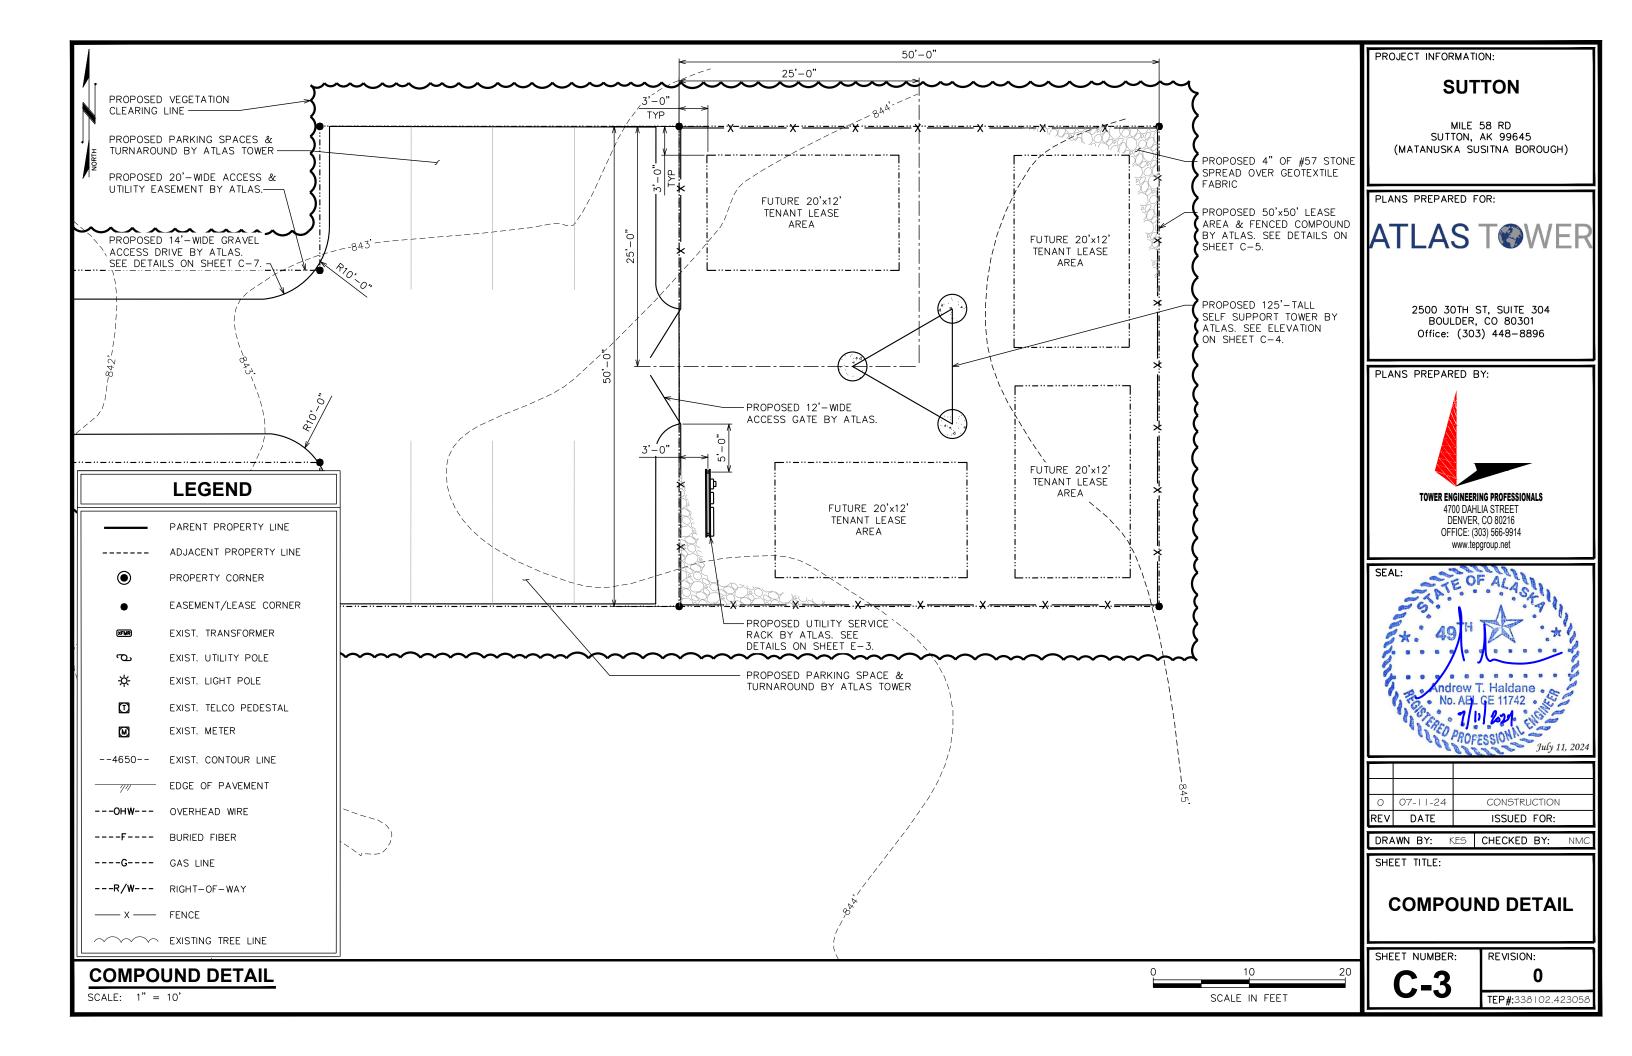
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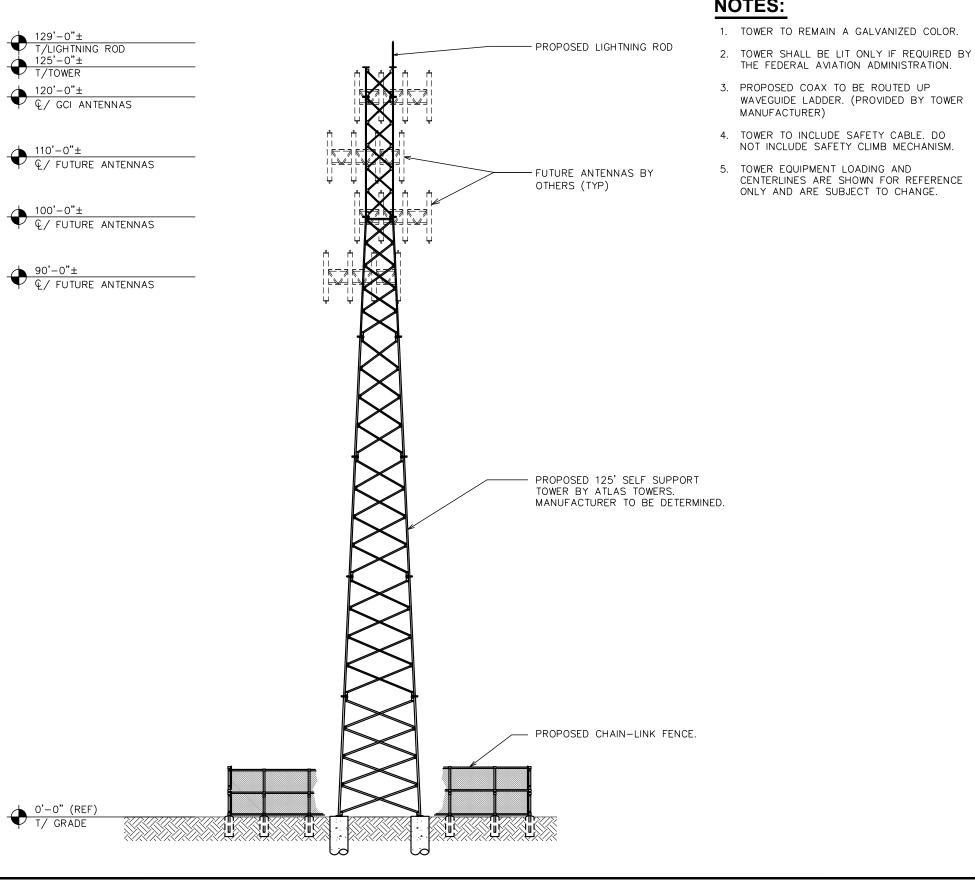
REVISION:

TEP#:338102.423058





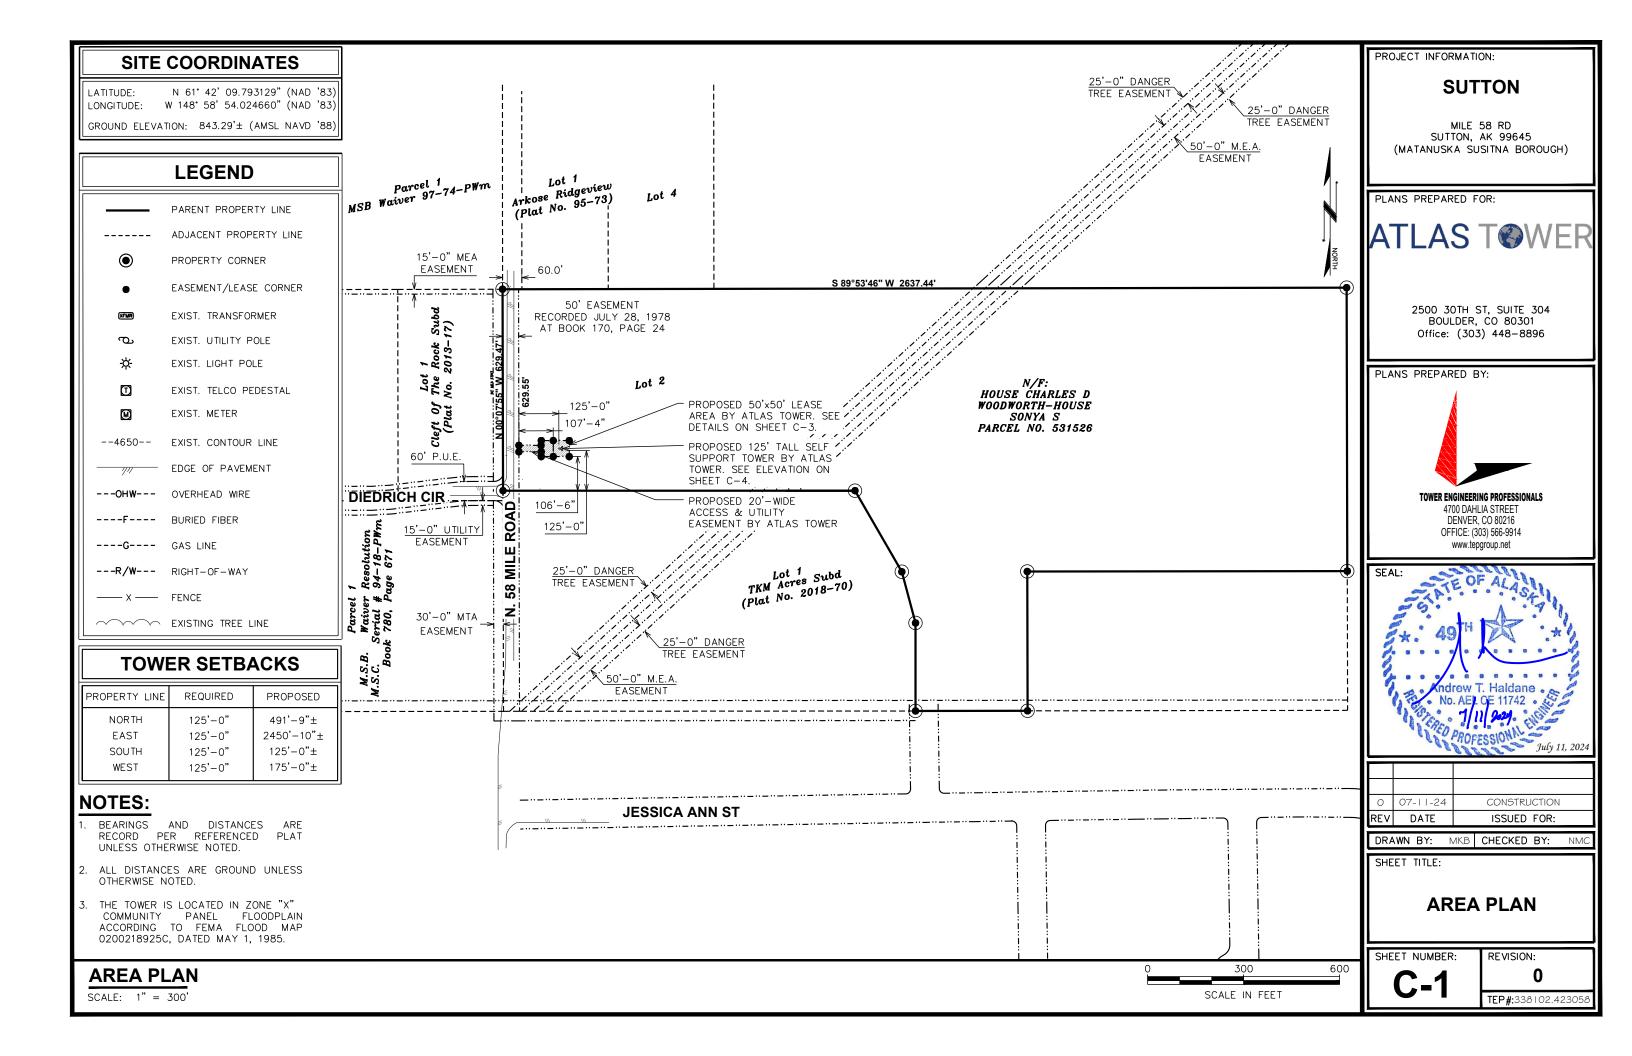

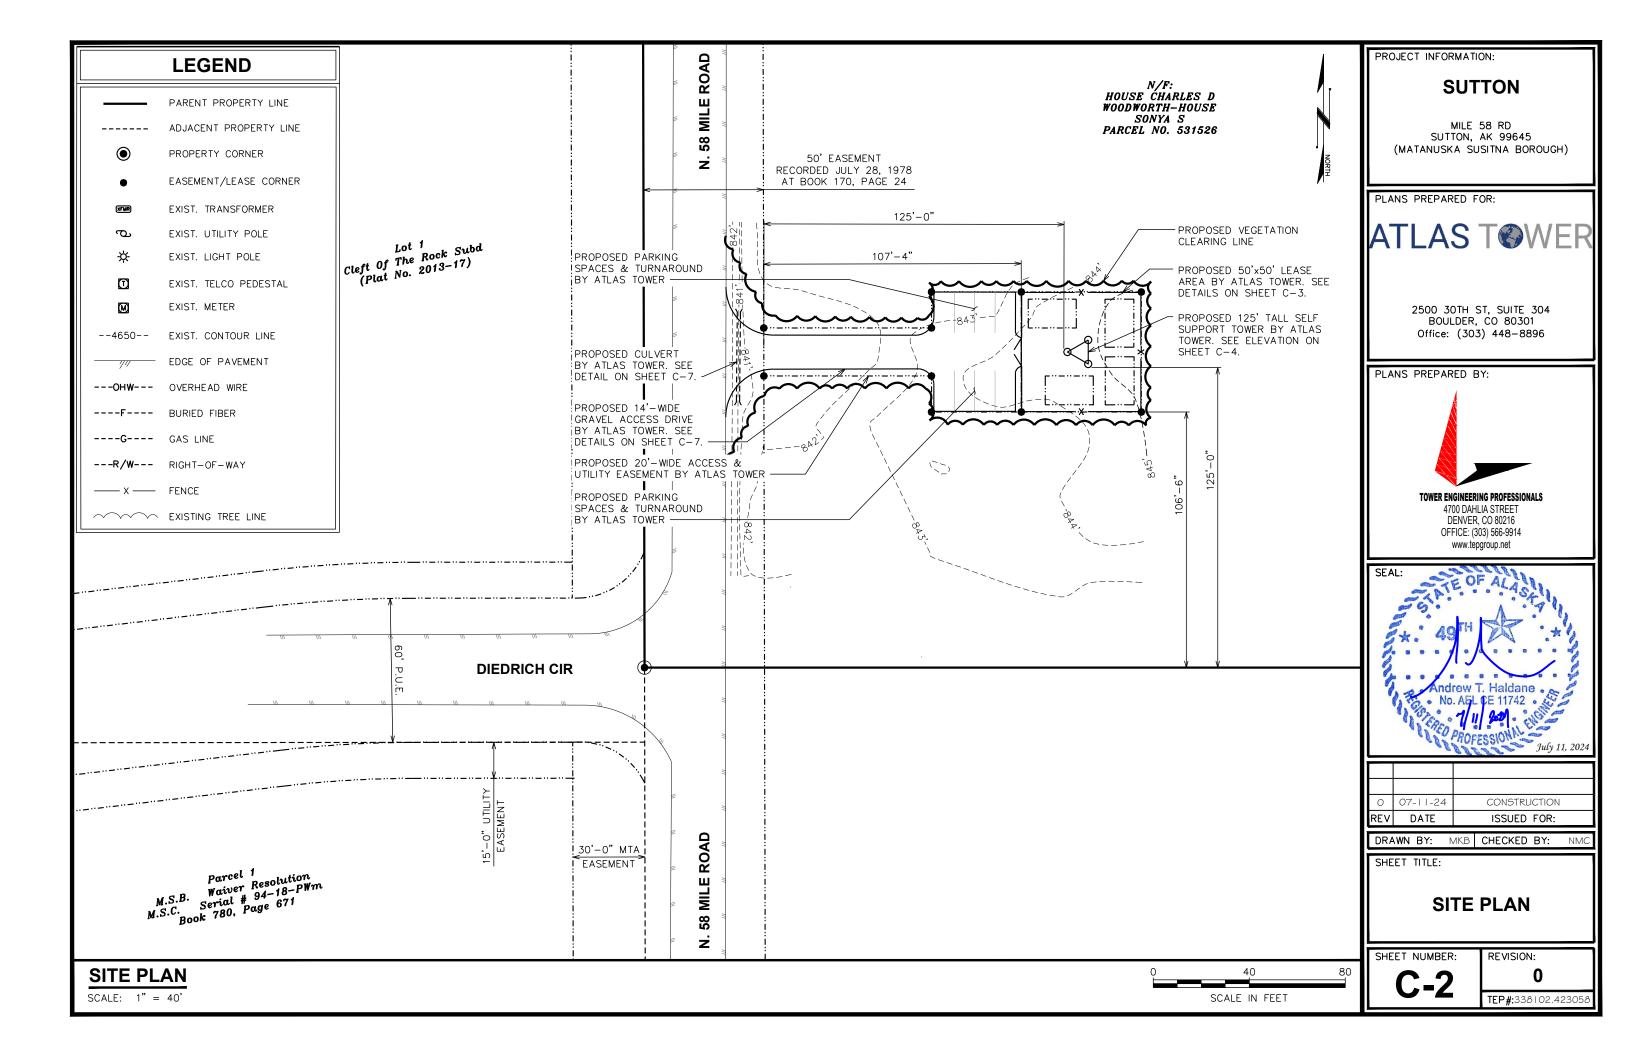

NOTES:

- WAVEGUIDE LADDER. (PROVIDED BY TOWER

PROJECT INFORMATION:

SUTTON

MILE 58 RD SUTTON, AK 99645 (MATANUSKA SUSITNA BOROUGH)

PLANS PREPARED FOR:




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0	07-11-24	CONSTRUCTION
REV	DATE	ISSUED FOR:

DRAWN BY: MKB CHECKED BY:

SHEET TITLE:

TOWER ELEVATION

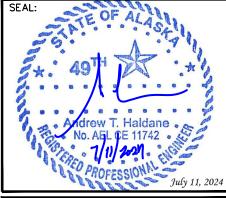SHEET NUMBER:


REVISION:


TEP#:338102.4230

TOWER ELEVATION

SCALE: $\frac{1}{16}$ " = 1'-0"

SCALE IN FEET

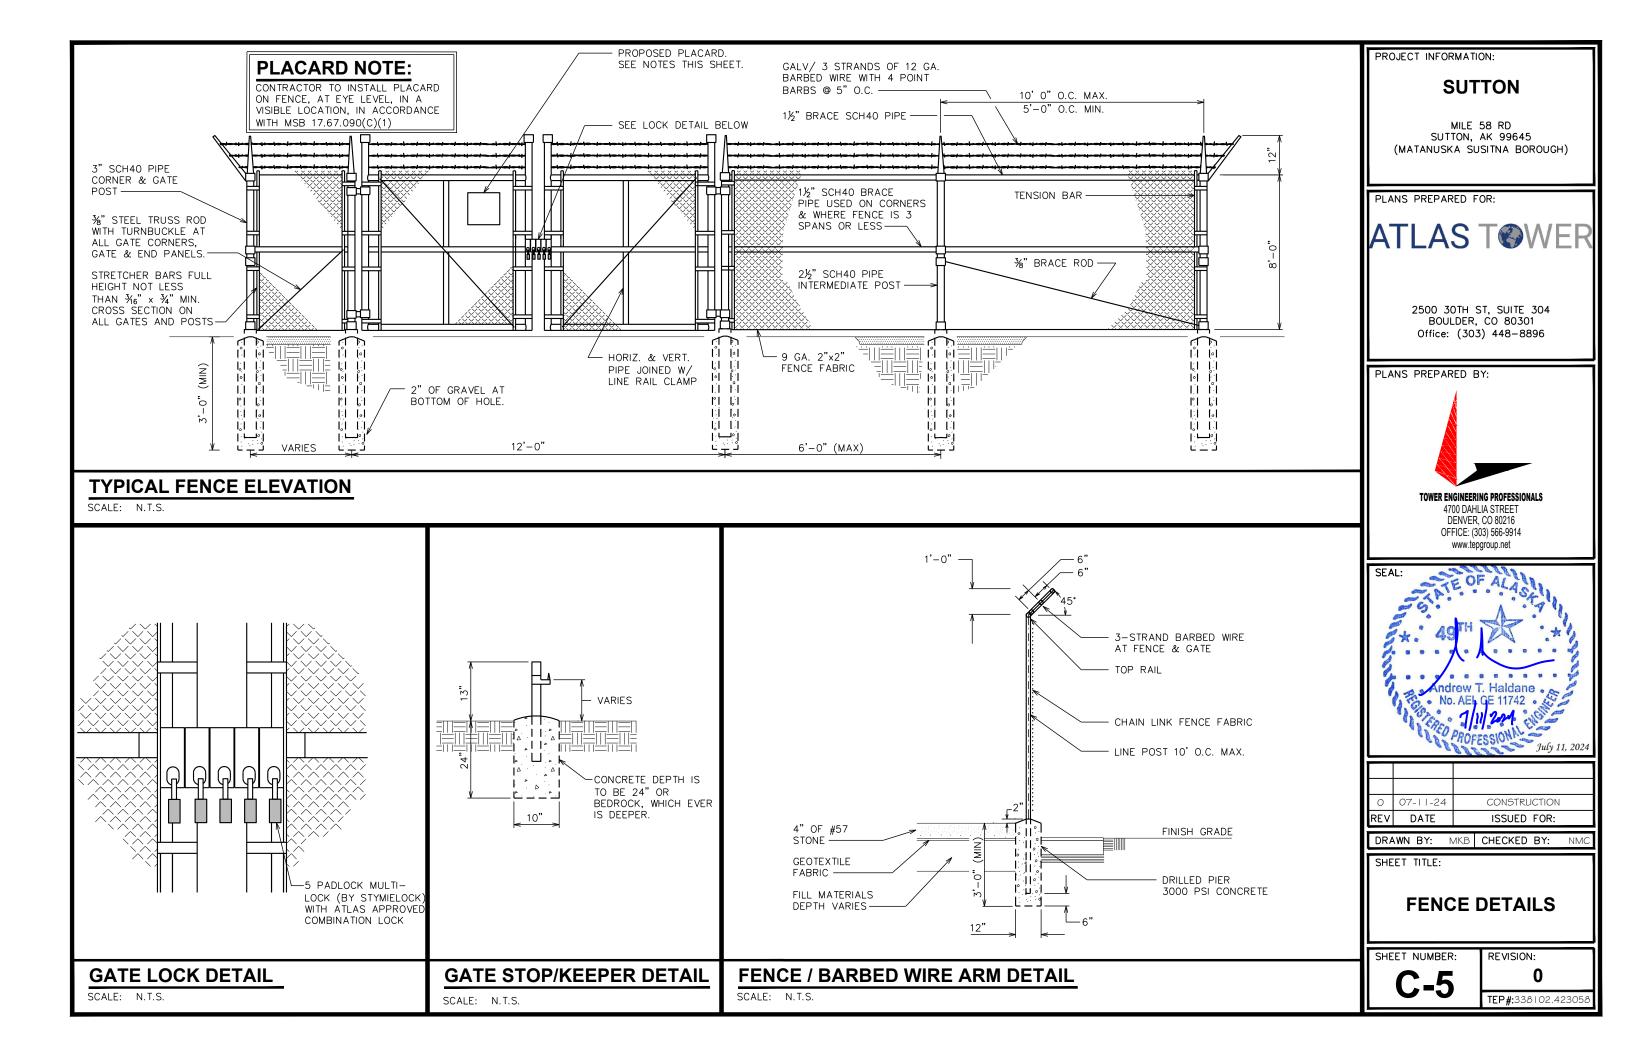

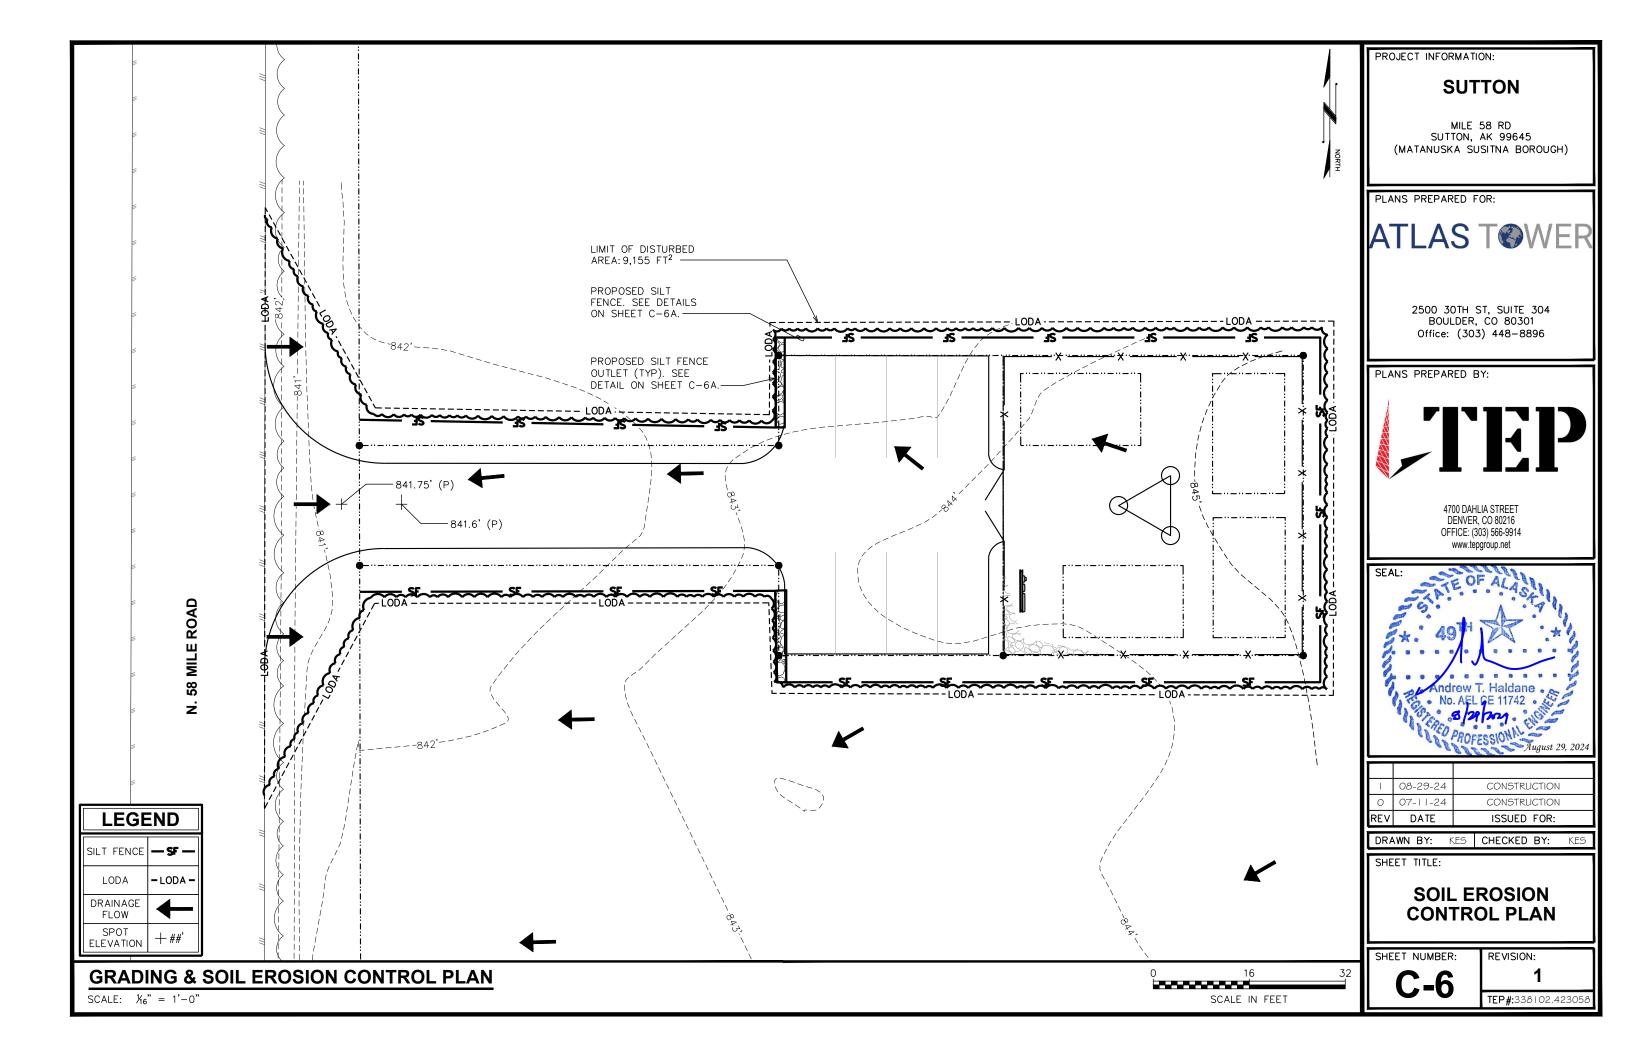


SITE GRADING NOTES:


- CONSTRUCTION WILL BE SEQUENCED SO THAT GRADING OPERATIONS CAN BEGIN AND END AS QUICKLY AS POSSIBLE.
- TEMPORARY SEEDING OR OTHER STABILIZATION, INCLUDING GRAVEL COVER ON ANY NEW ACCESS ROAD, WILL FOLLOW IMMEDIATELY AFTER GRADING.
- 3. THE JOB SUPERINTENDENT SHALL BE RESPONSIBLE FOR THE INSTALLATION AND MAINTENANCE OF ALL EROSION AND SEDIMENT CONTROL PRACTICES.
- 4. AFTER ACHIEVING ADEQUATE STABILIZATION, THE TEMPORARY E&S CONTROLS WILL BE CLEANED UP AND REMOVED.


GEOTEXTILE FABRIC NOTES:

- GEOTEXTILE FABRIC TO BE FASTENED SECURELY TO FENCE POST BY USE OF WIRE TIES OR HOG RINGS. 3 FASTENERS PER POST.
- ENDS OF INDIVIDUAL ROLLS OF GEOTEXTILE SHALL BE SECURELY FASTENED TO A COMMON POST OR OVERLAPPED 3' (MINIMUM).
- THIS DEVICE IS INTENDED TO CONTROL SHEET FLOW ONLY. IT WILL NOT BE USED IN AREAS OF CONCENTRATED FLOW WITH A DRAINAGE AREA OF ½ ACRE OR MORE.

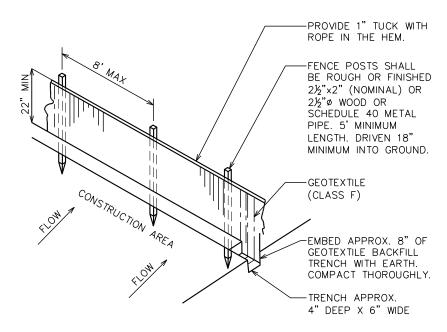

SILT FENCE

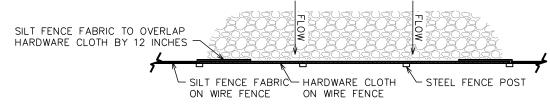

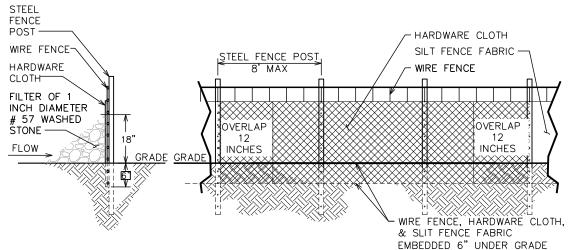

SILT FENCE OUTLET

PROJECT INFORMATION:


SUTTON

MILE 58 RD SUTTON, AK 99645 (MATANUSKA SUSITNA BOROUGH)

PLANS PREPARED FOR:




2500 30TH ST, SUITE 304 BOULDER, CO 80301 Office: (303) 448-8896

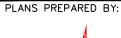



OWER ENGINEERING PROFESSIONA 4700 DAHLIA STREET DENVER, CO 80216 OFFICE: (303) 566-9914 www.tepgroup.net

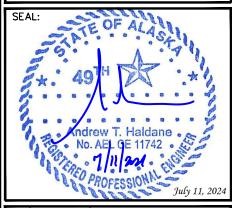

O 07-11-24 CONSTRUCTION
REV DATE ISSUED FOR:

DRAWN BY:

SHEET TITLE: "

SILT FENCE DETAIL


SHEET NUMBER:

REVISION:

CHECKED BY:

TEP#:338102.423058

SILT FENCE DETAIL

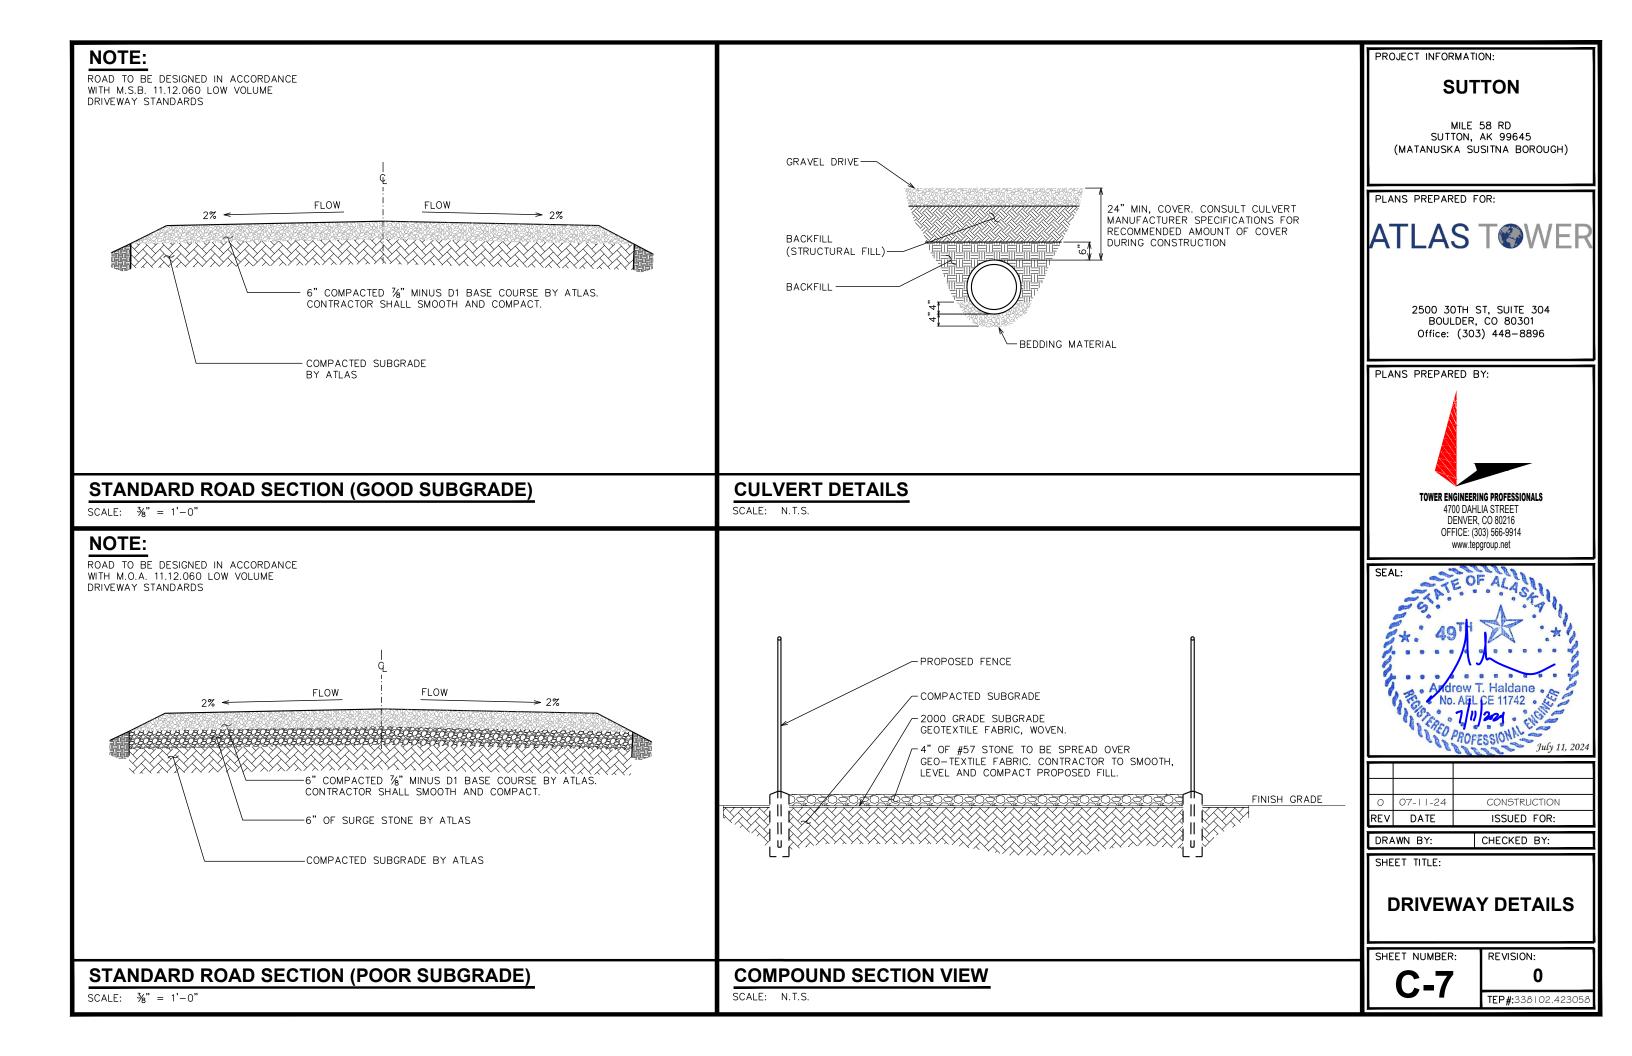


NOTES:

- . ALL SIGNS TO BE HUNG ON FENCE USING HOG RINGS OR ALUMINUM FENCE TIES. ZIP TIES OR REBAR WIRE WILL NOT BE ACCEPTABLE
- THE RED WARNING SIGN SHALL BE PLACED ON THE TOWER, IDEALLY AT THE BASE OF THE SAFETY CLIMB.


A NOTICE A

GUIDELINES FOR WORKING IN RADIOFREQUENCY ENVIRONMENTS

- All personnel should have electromagnetic energy (EME) awareness training.
- All personnel entering this site must be authorized.
- Obey all posted signs.
- Assume all antennas are active.
- Before working on antennas, notify owners and disable appropriate
- Maintain minimum 3 feet clearance from all antennas.
- Do not stop in front of antennas.
- Use personal RF monitors while working near antennas.
- Mever operate transmitters without shields during normal operation.
- Do not operate base station antennas in equipment room.

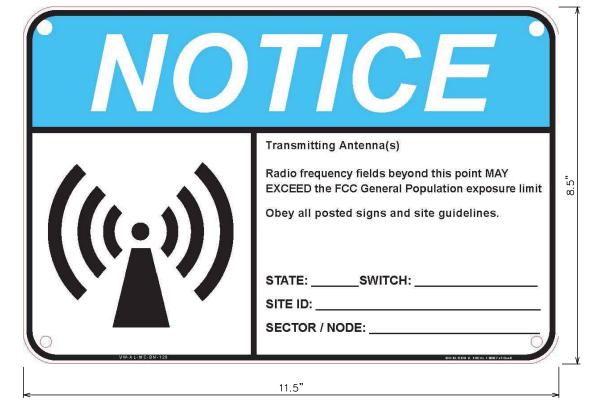



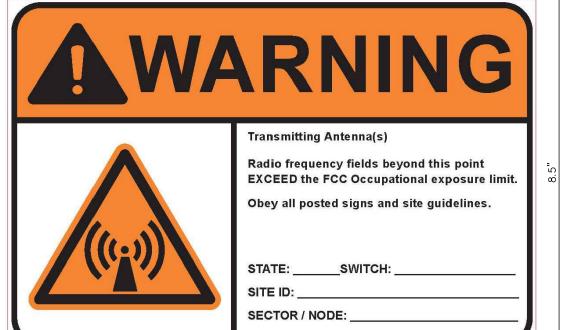

PROJECT INFORMATION:

SUTTON

MILE 58 RD SUTTON, AK 99645 (MATANUSKA SUSITNA BOROUGH)

PLANS PREPARED FOR:



2500 30TH ST, SUITE 304 BOULDER, CO 80301 Office: (303) 448-8896

PLANS PREPARED BY:



4700 DAHLIA STREET DENVER, CO 80216

OFFICE: (303) 566-9914 www.tepgroup.net

SEAL:	TE OF ALASA
	S. A. Fall
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N. F.	No. AEL CE 11742
e f	PROFESSION PROFESSION
To the	Andrew T. Haldane No. AEL CE 11742 APPLICATION AND THE PROPESSION AND

07-11-24 CONSTRUCTION ISSUED FOR: REV DATE

DRAWN BY: KES CHECKED BY:

SHEET TITLE:

SIGNAGE DETAILS

SHEET NUMBER:

REVISION:

TEP#:338102.4230

SITE NAME: Sutton FCC ASR #

> FOR LEASING AND ACCESS INFORMATION CALL: (303) 445-8896

SIGNAGE DETAILS

ELECTRICAL NOTES:

SCOPE:

1. PROVIDE LABOR, MATERIALS, INSPECTION, AND TESTING TO PROVIDE CODE COMPLIANCE FOR ELECTRIC, TELEPHONE, AND GROUNDING/LIGHTNING SYSTEMS.

CODES:

- 1. THE INSTALLATION SHALL COMPLY WITH APPLICABLE LAWS AND CODES. THESE INCLUDE BUT ARE NOT LIMITED TO THE LATEST ADOPTED EDITIONS OF:
 - A. THE NATIONAL ELECTRICAL SAFETY CODE B. THE NATIONAL ELECTRIC CODE - NFPA-70 C. REGULATIONS OF THE SERVING UTILITY COMPANY
- D. LOCAL AND STATE AMENDMENTS E. THE INTERNATIONAL ELECTRIC CODE -
- IEC (WHERE APPLICABLE)
- 2. PERMITS REQUIRED SHALL BE OBTAINED BY THE CONTRACTOR.
- 3. AFTER COMPLETION AND FINAL INSPECTION OF THE WORK, THE OWNER SHALL BE FURNISHED A CERTIFICATE OF COMPLETION AND APPROVAL.

1. UPON COMPLETION OF THE INSTALLATION, OPERATE AND ADJUST THE EQUIPMENT AND SYSTEMS TO MEET SPECIFIED PERFORMANCE REQUIREMENTS. THE TESTING SHALL BE DONE BY QUALIFIED PERSONNEL.

GUARANTEF:

- 1. IN ADDITION TO THE GUARANTEE OF THE EQUIPMENT BY THE MANUFACTURER, EACH PIECE OF EQUIPMENT SPECIFIED HEREIN SHALL ALSO BE GUARANTEED FOR DEFECTS OF MATERIAL OR WORKMANSHIP OCCURRING DURING A PERIOD OF ONE (1) YEAR FROM FINAL ACCEPTANCE OF THE WORK BY THE OWNER AND WITHOUT EXPENSE TO THE OWNER
- 2. THE WARRANTEE CERTIFICATES & GUARANTEES FURNISHED BY THE MANUFACTURERS SHALL BE TURNED OVER TO THE OWNER

UTILITY CO-ORDINATION:

1. CONTRACTOR SHALL COORDINATE WORK WITH THE POWER AND TELEPHONE COMPANIES AND SHALL COMPLY WITH THE SERVICE REQUIREMENTS OF EACH UTILITY COMPANY.

EXAMINATION OF SITE:

1. PRIOR TO BEGINNING WORK, THE CONTRACTOR SHALL VISIT THE SITE OF THE JOB AND SHALL FAMILIARIZE HIMSELF WITH THE CONDITIONS AFFECTING THE PROPOSED ELECTRICAL INSTALLATION AND SHALL MAKE PROVISIONS AS TO THE COST THEREOF. FAILURE TO COMPLY WITH THE INTENT OF THIS SECTION WILL IN NO WAY RELIEVE THE CONTRACTOR OF PERFORMING THE WORK NECESSARY FOR A COMPLETE AND WORKING SYSTEM OR SYSTEMS.

CUTTING. PATCHING AND EXCAVATION:

- 1. COORDINATION OF SLEEVES, CHASES, ETC., BETWEEN SUBCONTRACTORS WILL BE REQUIRED PRIOR TO THE CONSTRUCTION OF ANY PORTION OF THE WORK. CUTTING AND PATCHING OF WALLS, PARTITIONS, FLOORS, AND CHASES IN CONCRETE, WOOD, STEEL OR MASONRY SHALL BE DONE AS PROVIDED ON THE DRAWINGS.
- 2. NECESSARY EXCAVATIONS AND BACKFILLING INCIDENTAL TO THE ELECTRICAL WORK SHALL BE PROVIDED BY THE ELECTRICAL CONTRACTOR UNLESS SPECIFICALLY NOTED OTHERWISE ON THE DRAWING.
- 3. SEAL PENETRATIONS THROUGH RATED WALLS, FLOORS, ETC., WITH APPROVED METHOD AS LISTED BY UL.

RACEWAYS / CONDUITS GENERAL:

- CONDUCTORS SHALL BE INSTALLED IN LISTED RACEWAYS. CONDUIT SHALL BE RIGID STEEL, EMT, SCH40 PVC, OR SCH80PVC AS INDICATED ON THE DRAWINGS. THE RACEWAY SYSTEM SHALL BE COMPLETE COMPLETE BEFORE INSTALLING CONDUCTORS.
- 2. EXTERIOR RACEWAYS AND GROUNDING SLEEVES SHALL BE SEALED AT POINTS OF ENTRANCE AND EXIT. THE RACEWAY SYSTEM SHALL BE BONDED PER NEC.

EXTERIOR CONDUIT:

- 1. EXPOSED CONDUIT SHALL BE NEATLY INSTALLED AND RUN PARALLEL OR PERPENDICULAR TO STRUCTURAL ELEMENTS. SUPPORTS AND MOUNTING HARDWARE SHALL BE HOT DIPPED GALVANIZED STEEL.
- 2. WHERE INSTALLED ON EXTERIOR STRUCTURES OR EXPOSED TO DAMAGE, THE CONDUIT SHALL BE RIGID STEEL.
- 3. UNDERGROUND CONDUITS SHALL BE RIGID STEEL, SCH40 PVC, OR SCH80 PVC AS INDICATED ON THE DRAWINGS.
- 4. BURIAL DEPTH OF CONDUITS SHALL BE AS REQUIRED BY CODE FOR EACH SPECIFIC CONDUIT TYPE AND APPLICATION, BUT SHALL NOT BE LESS THAN THE FROST DEPTH AT THE SITE.
- 5. CONDUIT ROUTES ARE SCHEMATIC. CONTRACTOR SHALL FIELD VERIFY ROUTES BEFORE BID. COORDINATE ROUTE WITH WIRELESS CARRIER AND/OR BUILDING OWNER.

INTERIOR CONDUIT:

- 1. CONCEALED CONDUIT IN WALLS OR INTERIOR SPACES ABOVE GRADE MAY BE EMT.
- 2. CONDUIT RUNS SHALL USE APPROVED COUPLINGS AND CONNECTORS. PROVIDE INSULATED BUSHING FOR ALL CONDUIT TERMINATIONS. CONDUIT RUNS IN A WET LOCATION SHALL HAVE WATERPROOF FITTINGS.
- 3. PROVIDE SUPPORTS FOR CONDUITS IN ACCORDANCE WITH NEC REQUIREMENTS. CONDUITS SHALL BE SIZED AS REQUIRED BY NEC

EQUIPMENT:

- 1. DISCONNECT SWITCHES SHALL BE SERVICE ENTRANCE RATED, HEAVY DUTY TYPE.
- 2. CONTRACTOR SHALL VERIFY MAXIMUM AVAILABLE FAULT CURRENT AND COORDINATE INSTALLATION WITH THE LOCAL UTILITY BEFORE STARTING WORK. CONTRACTOR WILL VERIFY THAT EXISTING CIRCUIT BREAKERS ARE RATED FOR MORE THAN AVAILABLE FAULT CURRENT AND REPLACE AS NECESSARY.
- 3. NEW CIRCUIT BREAKERS SHALL BE RATED TO WITHSTAND THE MAXIMUM AVAILABLE FAULT CURRENT AS DETERMINED BY THE LOCAL UTILITY.

CONDUCTORS:

- 1. FURNISH AND INSTALL CONDUCTORS SPECIFIED IN THE DRAWINGS. CONDUCTORS SHALL BE COPPER AND SHALL HAVE TYPE THWN (MIN) (75° C) INSULATION, RATED FOR 600 VOLTS.
- 2. THE USE OF ALUMINUM CONDUCTORS SHALL BE LIMITED TO THE SERVICE FEEDERS INSTALLED BY THE UTILITY.
- 3. CONDUCTORS SHALL BE PROVIDED AND INSTALLED AS FOLLOWS:
 - A. MINIMUM WIRE SIZE SHALL BE #12 AWG.
 - CONDUCTORS SIZE #8 AND LARGER SHALL BE STRANDED. CONDUCTORS SIZED #10 AND #12 MAY BE SOLID OR STRANDED.
 - CONNECTION FOR #10 AWG #12 AWG SHALL BE BY TWISTING TIGHT AND INSTALLING INSULATED PRESSURE OR WIRE NUT CONNECTIONS.
 - CONNECTION FOR #8 AWG AND LARGER SHALL BE BY USE OF STEEL CRIMP-ON SLEEVES WITH NYLON INSULATOR.
- 3. CONDUCTORS SHALL BE COLOR CODED IN ACCORDANCE WITH NEC STANDARDS.

UL COMPLIANCE:

1. ELECTRICAL MATERIALS, DEVICES, CONDUCTORS, APPLIANCES, AND EQUIPMENT SHALL BE LABELED/LISTED BY UL OR ACCEPTED BY JURISDICTION (I.E., LOCAL COUNTY OR STATE) APPROVED THIRD PARTY TESTING AGENCY.

- 1. ELECTRICAL NEUTRALS, RACEWAYS AND NON-CURRENT CARRYING PARTS OF ELECTRICAL EQUIPMENT AND ASSOCIATED ENCLOSURES SHALL BE GROUNDED IN ACCORDANCE WITH NEC ARTICLE 250. THIS SHALL INCLUDE NEUTRAL CONDUCTORS, CONDUITS, SUPPORTS, CABINETS, BOXES, GROUND BUSSES, ETC. THE NEUTRAL CONDUCTOR FOR EACH SYSTEM SHALL BE GROUNDED AT A SINGLE POINT.
- 2. PROVIDE GROUND CONDUCTOR IN RACEWAYS PER NEC.

INTERIOR GROUND RING (HALO)

PERSONAL COMMUNICATION SYSTEM

NATIONAL ELECTRIC CODE

KILOWATTS

PHASE

PANEL

PCS

PNL

- 3. PROVIDE BONDING AND GROUND TO MEET NFPA 780 "LIGHTNING PROTECTION" AS A MINIMUM.
- 4. PROVIDE GROUNDING SYSTEM AS INDICATED ON THE DRAWINGS, AS REQUIRED BY THE NATIONAL ELECTRIC CODE, RADIO EQUIPMENT MANUFACTURERS, AND MOTOROLA R56 (AS APPLICABLE).

ABBREVIATIONS AND LEGEND

PNLBD - PANELBOARD AMPERE ABOVE FINISHED GRADE PVC - RIGID NON-METALLIC CONDUIT ATS - AUTOMATIC TRANSFER SWITCH RGS - RIGID GALVANIZED STEEL CONDUIT AMERICAN WIRE GAUGE SW - SWITCH BARE COPPER WIRE **TGB** TOWER GROUND BAR BELOW FINISHED GRADE UL - UNDERWRITERS LABORATORIES BREAKER VOLTAGE CONDUIT W WATTS CKT CIRCUIT XFMR - TRANSFORMER DISC DISCONNECT XMTR TRANSMITTER EGR EXTERNAL GROUND RING ELECTRIC METALLIC TUBING - FLEXIBLE STEEL CONDUIT FSC GENERATOR GLOBAL POSITIONING SYSTEM KILOWATT-HOUR METER 冎 GROUND ISOLATED GROUND BAR

---E--- UNDERGROUND ELECTRICAL CONDUIT ----T---- UNDERGROUND TELEPHONE CONDUIT UNDERGROUND BONDING AND GROUNDING CONDUCTOR. GROUND ROD CADWELD GROUND ROD WITH INSPECTION WELL PROJECT INFORMATION:

SUTTON


MILE 58 RD SUTTON, AK 99645 (MATANUSKA SUSITNA BOROUGH)

PLANS PREPARED FOR:



2500 30TH ST, SUITE 304 BOULDER, CO 80301 Office: (303) 448-8896



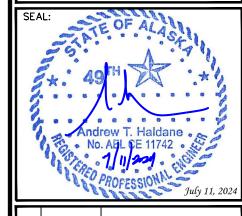

CONSTRUCTION 07-11-24 REV DATE ISSUED FOR:

DRAWN BY:

KES | CHECKED BY:


SHEET TITLE:

ELECTRICAL NOTES

SHEET NUMBER:

REVISION:


TEP#:338102.4230

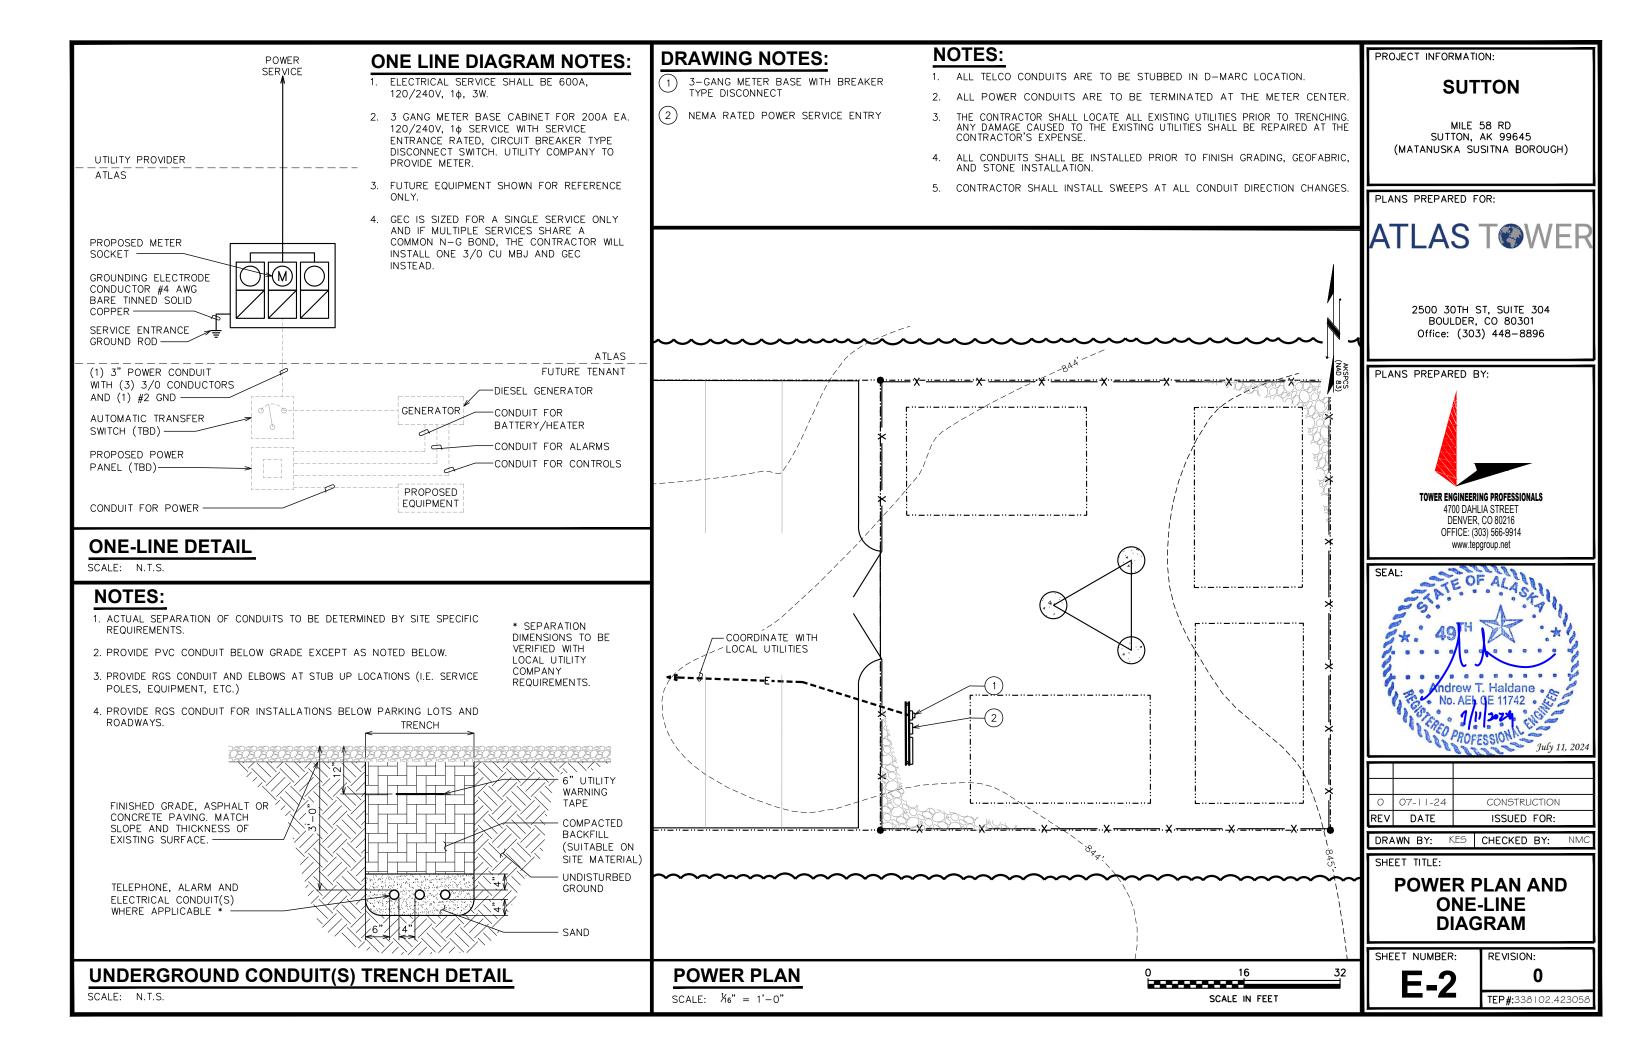

NOTES:

- 1) REFER TO THE SITE LAYOUT PLAN FOR THE EXACT LOCATION OF THE H-FRAME.
- (2) CONTRACTOR TO COORDINATE WITH LOCAL UTILITY COMPANY FOR METER.
- (3) UTILITY COMPANY TO PROVIDE AND INSTALL METER SOCKET.
- (ART. 110.26), STATE, OR LOCAL CODES ARE MAINTAINED BOTH ON THE FRONT SIDE AND THE BACK SIDE OF THE H-FRAME PRIOR TO INSTALLATION.
- 5 SHOW LOCATION (INCLUDING DIMENSIONS) OF ALL CAPPED UNDERGROUND CONDUIT ON FINAL AS-BUILT DRAWINGS SUBMITTED TO OWNER.

- 6 COORDINATE EXACT LOCATION OF UNDERGROUND FEEDERS AND CIRCUITRY WITH THE OWNER.
- 7 CONTRACTOR SHALL COORDINATE EFFORTS WITH (LOCAL, ELECTRICAL) AUTHORITY HAVING JURISDICTION (AHJ) AND OTHER TRADES TO DETERMINE "FROST" LINE, AND TYPE(S) OF RACEWAYS REQUIRED FOR INSTALLATION.
- (8) BOND ALL ELECTRICAL EQUIPMENT TO RACK.
- 9 DIMENSIONS SHOWN ARE APPROXIMATE AND MAY BE ALTERED IN THE FIELD AS APPROVED BY OWNER TO BETTER SUIT ACTUAL CONDITIONS OR EQUIPMENT RECEIVED.

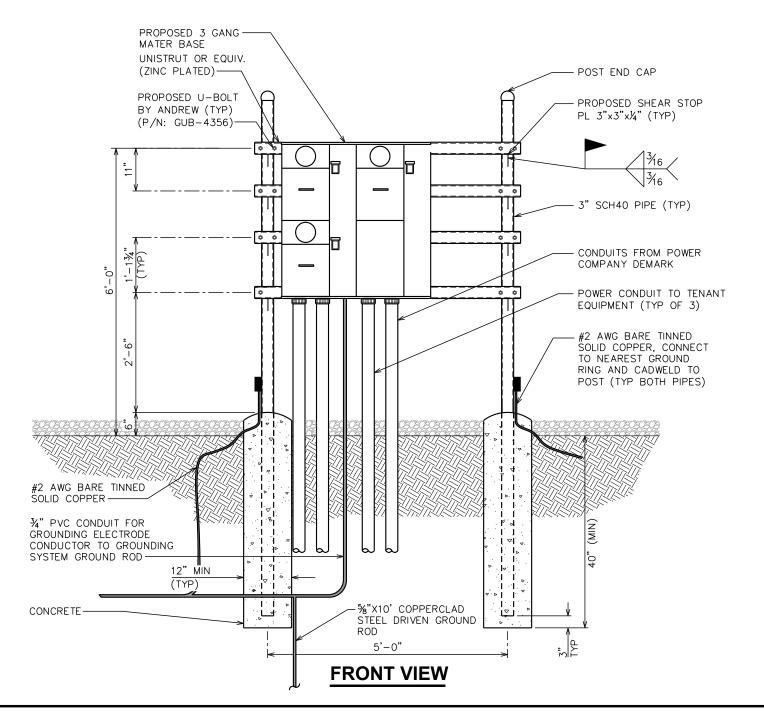

PROJECT INFORMATION:

SUTTON


MILE 58 RD SUTTON, AK 99645 (MATANUSKA SUSITNA BOROUGH)

PLANS PREPARED FOR:




2500 30TH ST, SUITE 304 BOULDER, CO 80301 Office: (303) 448-8896

PLANS PREPARED BY:

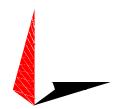

TOWER ENGINEERING PROFESSIONALS
4700 DAHLIA STREET
DENVER, CO 80216
OFFICE: (303) 566-9914
www.tepgroup.net

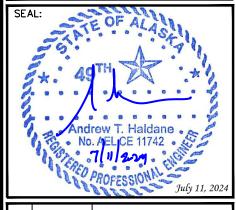

O 07-11-24 CONSTRUCTION

REV DATE ISSUED FOR:

DRAWN BY: KES CHECKED BY: ARB

SHEET TITLE:

SERVICE RACK DETAILS

SHEET NUMBER:

REVISION:

TEP#:338102.4230


SERVICE RACK DETAILS

SCALE: $\frac{1}{2}$ " = 1'-0"

SCALE IN FEET

DRAWING NOTES:

- (1) %"x10' COPPER GROUND ROD (TYP).
- \bigodot Gate post bonding. See detail on this sheet.
- 3 FENCE GATE GROUNDING. SEE DETAIL ON THIS SHEET.
- 4 PROPOSED INSPECTION WELL. SEE DETAIL ON SHEET E-5.
- PROPOSED TOWER GROUND RING. #2 COPPER CONDUCTOR—BARE TINNED BURIED 50" BFG BY ATLAS TOWER.

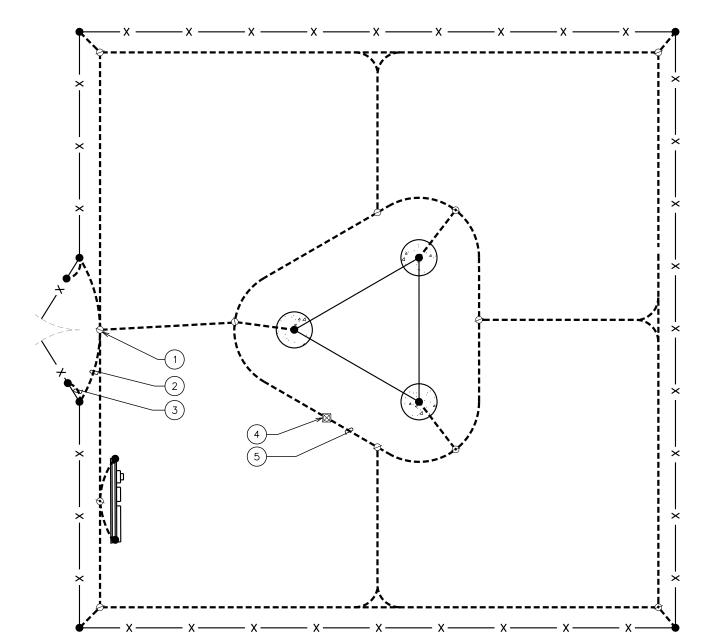

GROUNDING NOTES

- 1. GROUNDING ELECTRODES SHALL BE CONNECTED IN A RING USING #2 SOLID CONDUCTOR. THE TOP OF THE GROUND RODS AND THE CONDUCTOR SHALL BE 60" (MIN) BELOW FINISHED GRADE, GROUNDING ELECTRODES SHALL BE DRIVEN ON 10'-0" CENTERS. (6'-0" MINIMUM; 16'-0" MAXIMUM)
- 2. BONDING OF THE GROUNDED CONDUCTOR (NEUTRAL) AND THE GROUNDING CONDUCTOR SHALL BE AT THE SERVICE DISCONNECTING MEANS. BONDING JUMPER SHALL BE INSTALLED PER N.E.C. ARTICLE 250.30.
- 3. ROUND SHELTER TO GROUND RING PER NSTD46 CELL SITE GROUNDING AND LIGHTING PROTECTION, ISSUED 2/1/11.

PROJECT INFORMATION:

SUTTON

MILE 58 RD SUTTON, AK 99645 (MATANUSKA SUSITNA BOROUGH)

PLANS PREPARED FOR:




2500 30TH ST, SUITE 304 BOULDER, CO 80301 Office: (303) 448-8896

PLANS PREPARED BY:



TOWER ENGINEERING PROFESSIONALS 4700 DAHLIA STREET DENVER, CO 80216

OFFICE: (303) 566-9914 www.tepgroup.net

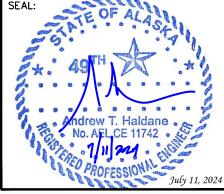

CONSTRUCTION 07-11-24 ISSUED FOR: REV DATE

DRAWN BY: KES CHECKED BY:


SHEET TITLE:

GROUNDING PLAN AND DETAILS

SHEET NUMBER:

REVISION:


TEP#:338102.423

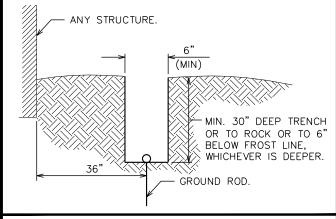

TRENCH DETAIL

SCALE: N.T.S.


CONNECTION (TYP). FLEXIBLE JUMPER.

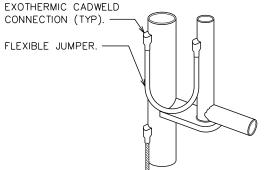


GROUNDING AT GATE POST

TYPICAL GROUNDING PLAN

SCALE: N.T.S.

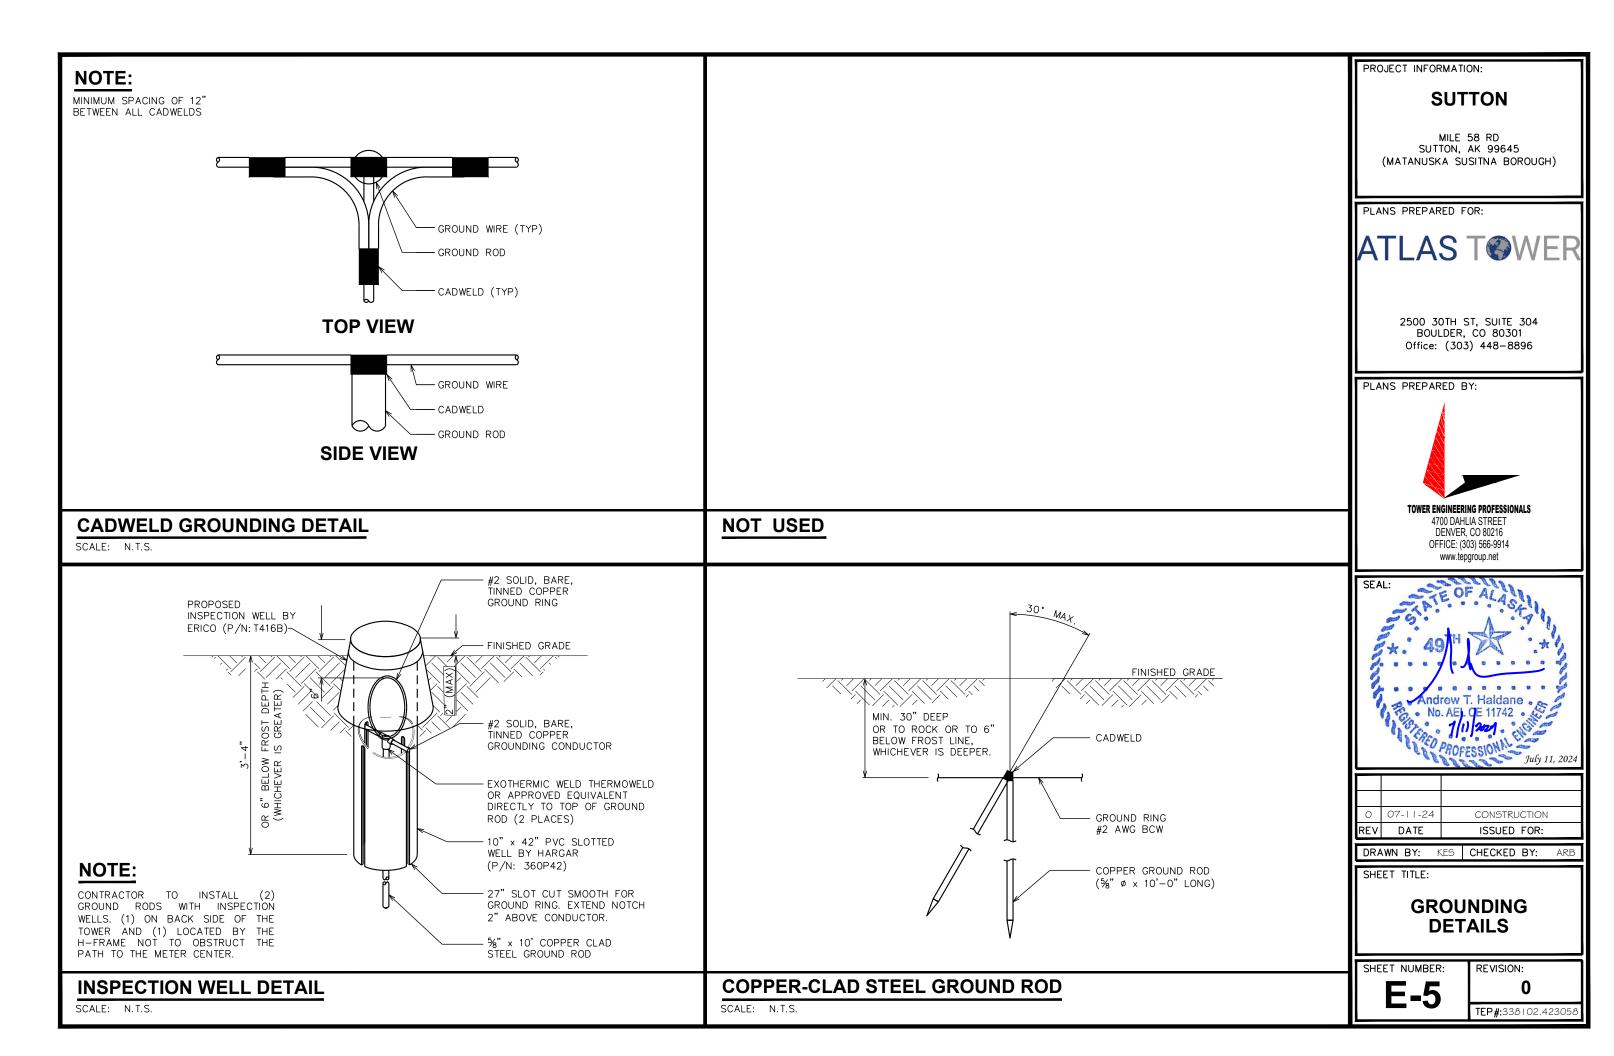

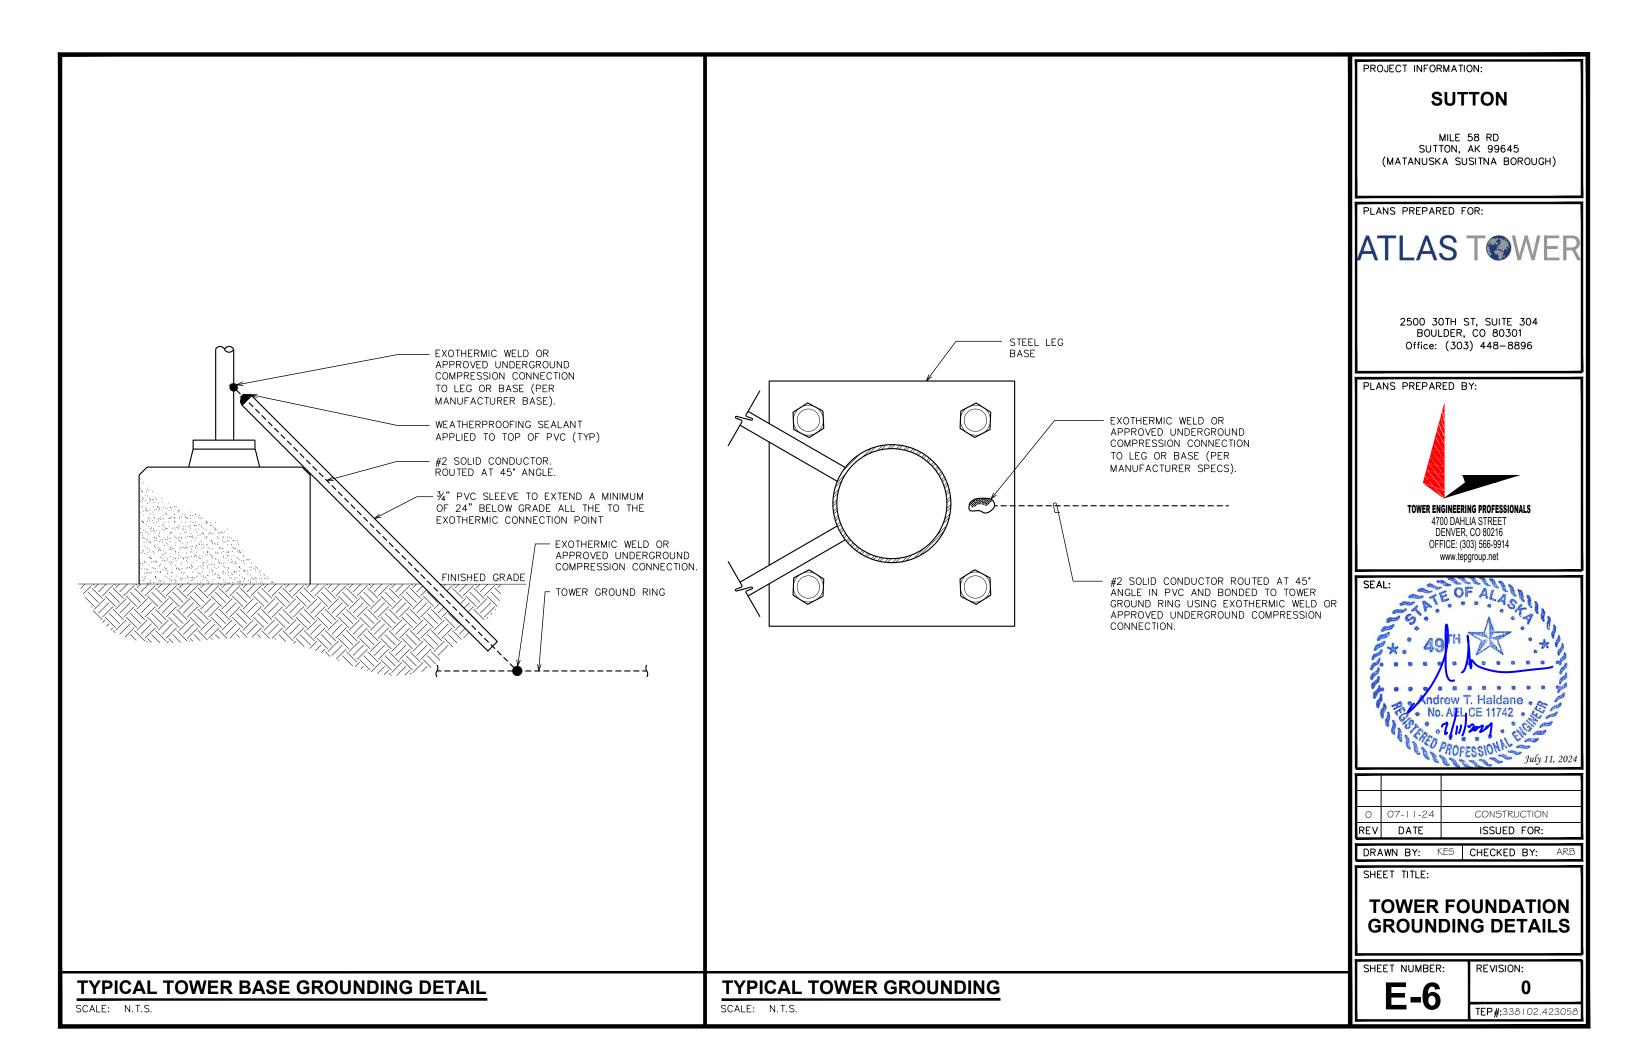



SITE NAME: SUTTON PROPOSED 125' SELF SUPPORT TOWER

MILE 58 RD SUTTON, AK 99645 (MATANUSKA SUSITNA BOROUGH COUNTY)



SITE NAME: SUTTON ADDRESS: MILE 58 RD

SUTTON, AK 99645

COUNTY: MATANUSKA SUSITNA BOROUGH

EXISTING VIEW: LOCATION 1









SITE NAME: SUTTON ADDRESS: MILE 58 RD

SUTTON, AK 99645

COUNTY: MATANUSKA SUSITNA BOROUGH

PROPOSED VIEW: LOCATION 1

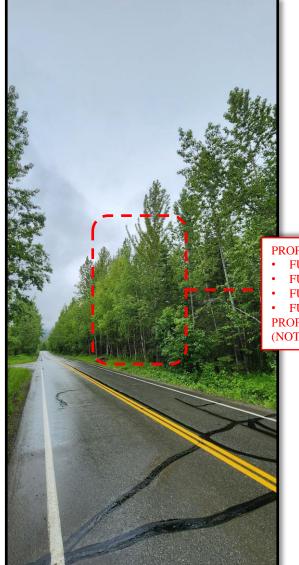

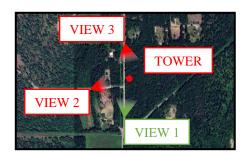

PROPOSED 125' SELF SUPPORT TOWER (NOT VISIBLE)

- FUTURE EQUIPMENT @ 115'-0" (NOT VISIBLE)
- FUTURE EQUIPMENT @ 105'-0" (NOT VISIBLE)
- FUTURE EQUIPMENT @ 95'-0" (NOT VISIBLE)
- FUTURE EQUIPMENT @ 85'-0" (NOT VISIBLE)

PROPOSED 50'x50' CHAIN LINK FENCED COMPOUND (NOT VISIBLE)



SITE NAME: SUTTON ADDRESS: MILE 58 RD

SUTTON, AK 99645

COUNTY: MATANUSKA SUSITNA BOROUGH

EXISTING VIEW: LOCATION 2







SITE NAME: SUTTON ADDRESS: MILE 58 RD

SUTTON, AK 99645

COUNTY: MATANUSKA SUSITNA BOROUGH

PROPOSED VIEW: LOCATION 2





PROPOSED 125' SELF SUPPORT TOWER

- FUTURE EQUIPMENT @ 115'-0"
- FUTURE EQUIPMENT @ 105'-0"
- FUTURE EQUIPMENT @ 95'-0"
- FUTURE EQUIPMENT @ 85'-0"

PROPOSED 50'x50' CHAIN LINK FENCED COMPOUND (NOT VISIBLE)



SITE NAME: SUTTON ADDRESS: MILE 58 RD

SUTTON, AK 99645

COUNTY: MATANUSKA SUSITNA BOROUGH

EXISTING VIEW: LOCATION 3









SITE NAME: SUTTON ADDRESS: MILE 58 RD

SUTTON, AK 99645

COUNTY: MATANUSKA SUSITNA BOROUGH

PROPOSED VIEW: LOCATION 3

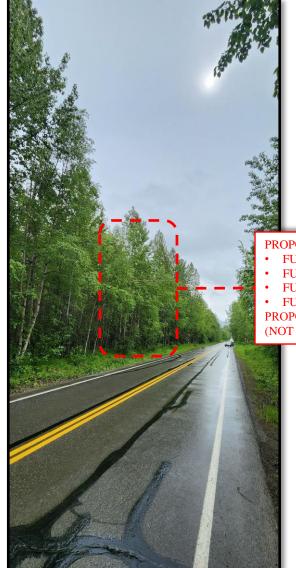

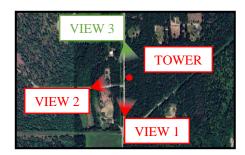

PROPOSED 125' SELF SUPPORT TOWER (NOT VISIBLE)

- FUTURE EQUIPMENT @ 115'-0" (NOT VISIBLE)
- FUTURE EQUIPMENT @ 105'-0" (NOT VISIBLE)
- FUTURE EQUIPMENT @ 95'-0" (NOT VISIBLE)
- FUTURE EQUIPMENT @ 85'-0" (NOT VISIBLE) PROPOSED 50'x50' CHAIN LINK FENCED COMPOUND

(NOT VISIBLE)



Issued Date: 07/30/2024

Mike Powers Atlas Tower 1, LLC 3002 Bluff Street Suite 300 Boulder, CO 80301

** DETERMINATION OF NO HAZARD TO AIR NAVIGATION **

The Federal Aviation Administration has conducted an aeronautical study under the provisions of 49 U.S.C., Section 44718 and if applicable Title 14 of the Code of Federal Regulations, part 77, concerning:

Structure: Antenna Tower Sutton - HOUSE

Location: Sutton, AK

Latitude: 61-42-09.70N NAD 83

Longitude: 148-58-54.00W

Heights: 843 feet site elevation (SE)

129 feet above ground level (AGL) 972 feet above mean sea level (AMSL)

This aeronautical study revealed that the structure does not exceed obstruction standards and would not be a hazard to air navigation provided the following condition(s), if any, is(are) met:

Based on this evaluation, marking and lighting are not necessary for aviation safety. However, if marking/lighting are accomplished on a voluntary basis, we recommend it be installed in accordance with FAA Advisory circular 70/7460-1 M.

This determination expires on 01/30/2026 unless:

- (a) the construction is started (not necessarily completed) and FAA Form 7460-2, Notice of Actual Construction or Alteration, is received by this office.
- (b) extended, revised, or terminated by the issuing office.
- (c) the construction is subject to the licensing authority of the Federal Communications Commission (FCC) and an application for a construction permit has been filed, as required by the FCC, within 6 months of the date of this determination. In such case, the determination expires on the date prescribed by the FCC for completion of construction, or the date the FCC denies the application.

NOTE: REQUEST FOR EXTENSION OF THE EFFECTIVE PERIOD OF THIS DETERMINATION MUST BE E-FILED AT LEAST 15 DAYS PRIOR TO THE EXPIRATION DATE. AFTER RE-EVALUATION OF CURRENT OPERATIONS IN THE AREA OF THE STRUCTURE TO DETERMINE THAT NO

SIGNIFICANT AERONAUTICAL CHANGES HAVE OCCURRED, YOUR DETERMINATION MAY BE ELIGIBLE FOR ONE EXTENSION OF THE EFFECTIVE PERIOD.

This determination is based, in part, on the foregoing description which includes specific coordinates, heights, frequency(ies) and power. Any changes in coordinates, heights, and frequencies or use of greater power, except those frequencies specified in the Colo Void Clause Coalition; Antenna System Co-Location; Voluntary Best Practices, will void this determination. Any future construction or alteration, including increase to heights, power, or the addition of other transmitters, requires separate notice to the FAA. This determination includes all previously filed frequencies and power for this structure.

If construction or alteration is dismantled or destroyed, you must submit notice to the FAA within 5 days after the construction or alteration is dismantled or destroyed.

This determination does include temporary construction equipment such as cranes, derricks, etc., which may be used during actual construction of the structure. However, this equipment shall not exceed the overall heights as indicated above. Equipment which has a height greater than the studied structure requires separate notice to the FAA.

This determination concerns the effect of this structure on the safe and efficient use of navigable airspace by aircraft and does not relieve the sponsor of compliance responsibilities relating to any law, ordinance, or regulation of any Federal, State, or local government body.

A copy of this determination will be forwarded to the Federal Communications Commission (FCC) because the structure is subject to their licensing authority.

If we can be of further assistance, please contact our office at (206) 231-2990, or paul.holmquist@faa.gov. On any future correspondence concerning this matter, please refer to Aeronautical Study Number 2024-AAL-442-OE.

Signature Control No: 625166549-628662256 (DNE)


Paul Holmquist Specialist

Attachment(s) Frequency Data Map(s)

cc: FCC

Frequency Data for ASN 2024-AAL-442-OE

LOW FREQUENCY	HIGH FREQUENCY	FREQUENCY UNIT	ERP	ERP UNIT
				-
6	7	GHz	55	dBW
6	7	GHz	42	dBW
10	11.7	GHz	55	dBW
10	11.7	GHz	42	dBW
17.7	19.7	GHz	55	dBW
17.7	19.7	GHz	42	dBW
21.2	23.6	GHz	55	dBW
21.2	23.6	GHz	42	dBW
614	698	MHz	1000	W
614	698	MHz	2000	W
698	806	MHz	1000	W
806	901	MHz	500	W
806	824	MHz	500	W
824	849	MHz	500	W
851	866	MHz	500	W
869	894	MHz	500	W
896	901	MHz	500	W
901	902	MHz	7	W
929	932	MHz	3500	W
930	931	MHz	3500	W
931	932	MHz	3500	W
932	932.5	MHz	17	dBW
935	940	MHz	1000	W
940	941	MHz	3500	W
1670	1675	MHz	500	W
1710	1755	MHz	500	W
1850	1910	MHz	1640	W
1850	1990	MHz	1640	W
1930	1990	MHz	1640	W
1990	2025	MHz	500	W
2110	2200	MHz	500	W
2305	2360	MHz	2000	W
2305	2310	MHz	2000	W
2345	2360	MHz	2000	W
2496	2690	MHz	500	W

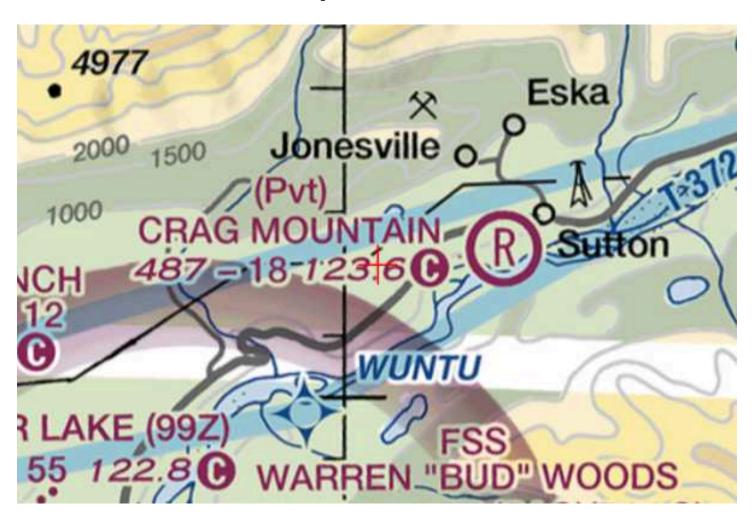

From: <u>Corinne Lindfors</u>

To: Rick Benedict; Peggy Horton

Cc: <u>Jason Ortiz</u>

Subject: FW: Section 106 Notification of SHPO/THPO Concurrence- Email ID #10094114

Date: Thursday, August 22, 2024 4:30:04 PM

Hi all,

Here is an FYI: Please let me know if I need to do anything else about this.

Thank you,

Corinne Lindfors

Matanuska-Susitna Borough Development Services Administrative Specialist 350 E. Dahlia Avenue Palmer, Alaska 99645

Corinne.lindfors@matsugov.us

PH: (907)861-8574

From: towernotifyinfo@fcc.gov <towernotifyinfo@fcc.gov>

Sent: Thursday, August 22, 2024 4:16 PM

To: Corinne Lindfors < Corinne.Lindfors@matsugov.us>

Subject: Section 106 Notification of SHPO/THPO Concurrence- Email ID #10094114

[EXTERNAL EMAIL - CAUTION: Do not open unexpected attachments or links.]

This is to notify you that the Lead SHPO/THPO has concurred with the following filing:

Date of Action: 08/22/2024

Direct Effect: No Historic Properties in Area of Potential Effects (APE) Visual Effect: No Historic Properties in Area of Potential Effects (APE)

Comment Text: None

File Number: 0011175415 TCNS Number: 282407

Purpose: New Tower Submission Packet

Notification Date: 7AM EST 07/30/2024

Applicant: Atlas Tower Companies Consultant: Trileaf Corporation

Positive Train Control Filing Subject to Expedited Treatment Under Program Comment:

No

Site Name: Sutton AK

Site Address: Mile 58 Road

Detailed Description of Project: Our client proposes to construct a 89' self-support tower, in a new 50'x50' lease area. A new 20'wide access/utility easement will go about 130' E from Mile 58 Rd to the lease area, w/ a turnaround area on W wall of comp.

Site Coordinates: 61-42-9.8 N, 148-58-54.0 W

City: Sutton

County: MATANUSKA-SUSITNA

State:AK

Lead SHPO/THPO: Alaska DNR, Ofc History & Archeology

NOTICE OF FRAUDULENT USE OF SYSTEM, ABUSE OF PASSWORD AND RELATED MISUSE

Use of the Section 106 system is intended to facilitate consultation under Section 106 of the National Historic Preservation Act and may contain information that is confidential, privileged or otherwise protected from disclosure under applicable laws. Any person having access to Section 106 information shall use it only for its intended purpose. Appropriate action will be taken with respect to any misuse of the system.